## ROXFORD STREET INDUSTRIAL PARK

15825 ROXFORD STREET SYLMAR, CA 91342



8811 Research Drive, Suite 200, Irvine, CA 92618 T: 949 474 1775 F: 949 553 9133





<u>OWNER:</u> ROXFORD XC, LLC 3010 OLD RANCH ROAD PARKWAY, SUITE 470 SEAL BEACH, CA 90740 PHONE: 562-546-0200

CONTACT: SHEAN KIM Sheank@xebecrealty.com

APPLICANT: XEBEC REALTY 3010 OLD RANCH ROAD PARKWAY, SUITE 470 SEAL BEACH, CA 90740 PHONE: 562-546-0200
CELL; 510-381-1611
CONTACT: SHEAN KIM Sheank@xebecrealty.com

ARCHITECT:
GAA ARCHITECTS, INC. 8811 RESEARCH DRIVE, SUITE 200 IRVINE, CA 92618
PHONE: 949-474-1775
FAX: 949-533-9133

CONTACT: ROGER DEITOS rogerd@GAAarchitects.com CIVIL: CA ENGINEERING, INC

13821 NEWPORT AVE., STE 110 TUSTIN, CA 92780 PHONE: 949-724-9480 CONTACT: FRED CORNWELL

5256 S MISSION ROAD, SUITE 121 FALLBROAK, CA, 92003 PHOLE: 760-842-8993

CONTACT: SCOTT PETERSON

## PROJECT TEAM

PROJECT RENDERINGS CONCEPTUAL GRADING PLAN

CONCEPTUAL LANDSCAPE PLAN L-2 CONCEPTUAL LANDSCAPE PLAN

OVERALL SITE PLAN ENLARGE SITE PLAN BLDG 1 ENLARGE SITE PLAN BLDG 2 BUILDING 1 FLOOR PLAN BUILDING 2 FLOOR PLAN BUILDING 1 ROOF PLAN BUILDING 2 ROOF PLAN BUILDING 1 ELEVATIONS BUILDING 1 ELEVATIONS BUILDING 2 ELEVATIONS BUILDING 2 ELEVATIONS


SHEET INDEX

NO. DESCRIPTION ↑ PROGRESS SET

COVER

ALL DRAWINGS AND WRITTEN MATERIAL APPEARING HEREIN CONSTITUTE THE ORIGINAL AND UNPUBLISHED WORK OF THE ARCHITECT AND THE SAME MAY NOT BE DUPLICATED, USED OR DISCLOSED WITHOUT THE EXPRESS WRITTEN CONSENT OF THE ARCHITECT. © GAA ARCHITECTS. ALL RIGHTS RESERVED.

> XRP040.01 7/28/21

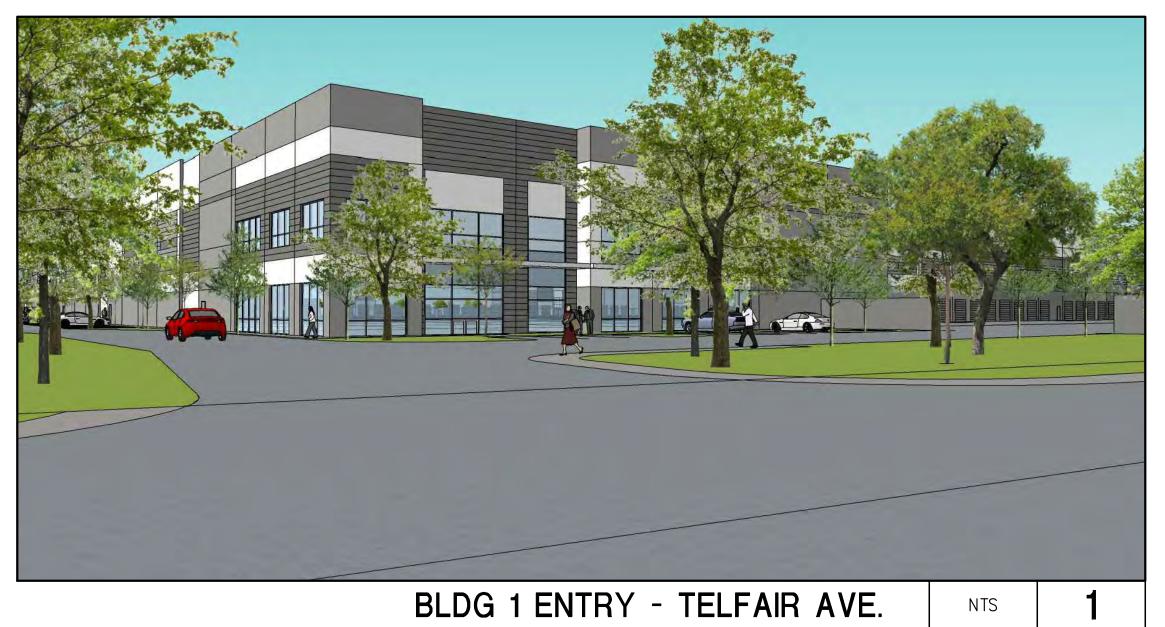








8811 Research Drive, Suite 200, Irvine, CA 92618

T: 949 474 1775 F: 949 553 9133





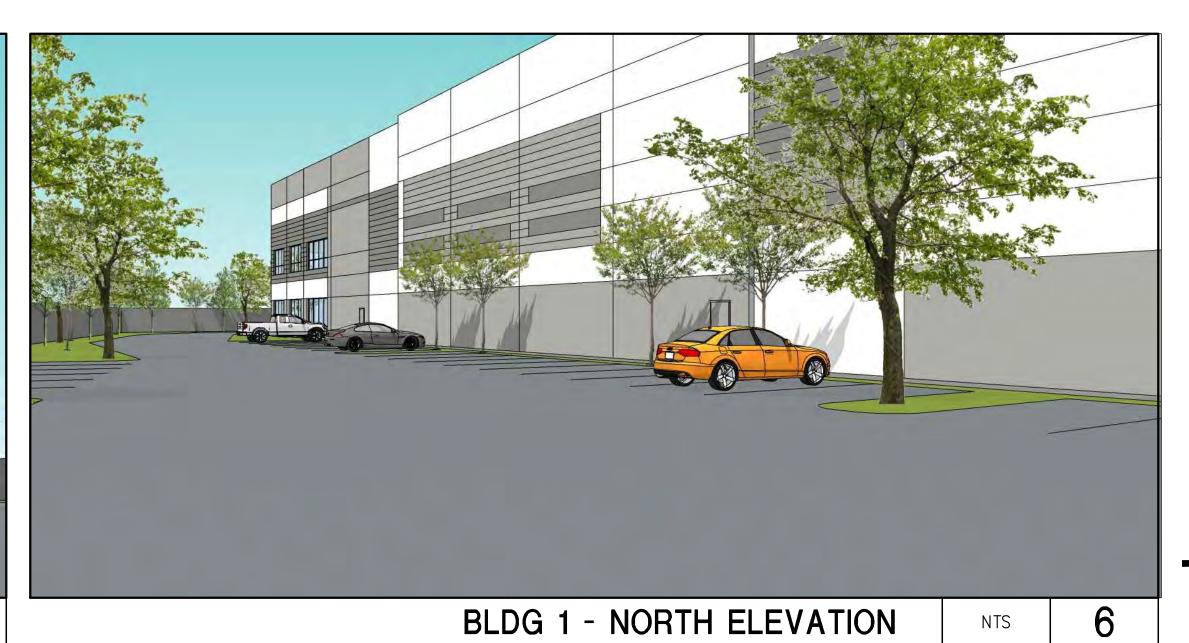









	NO.	DESCRIPTION	DATE
		PROGRESS SET	07/30/21
~			



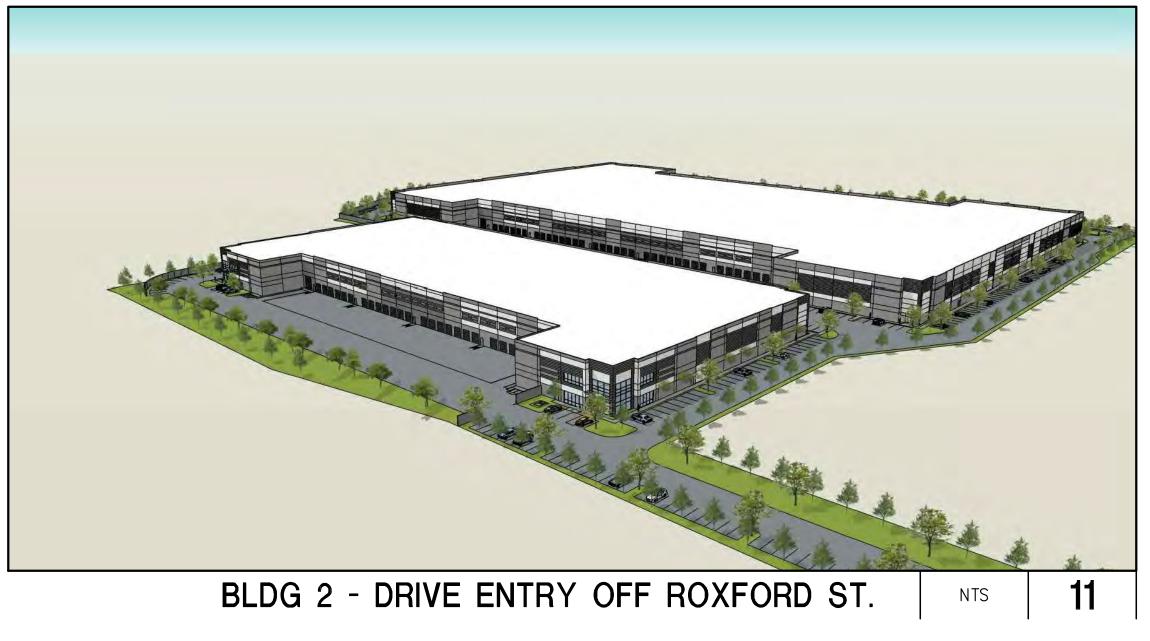


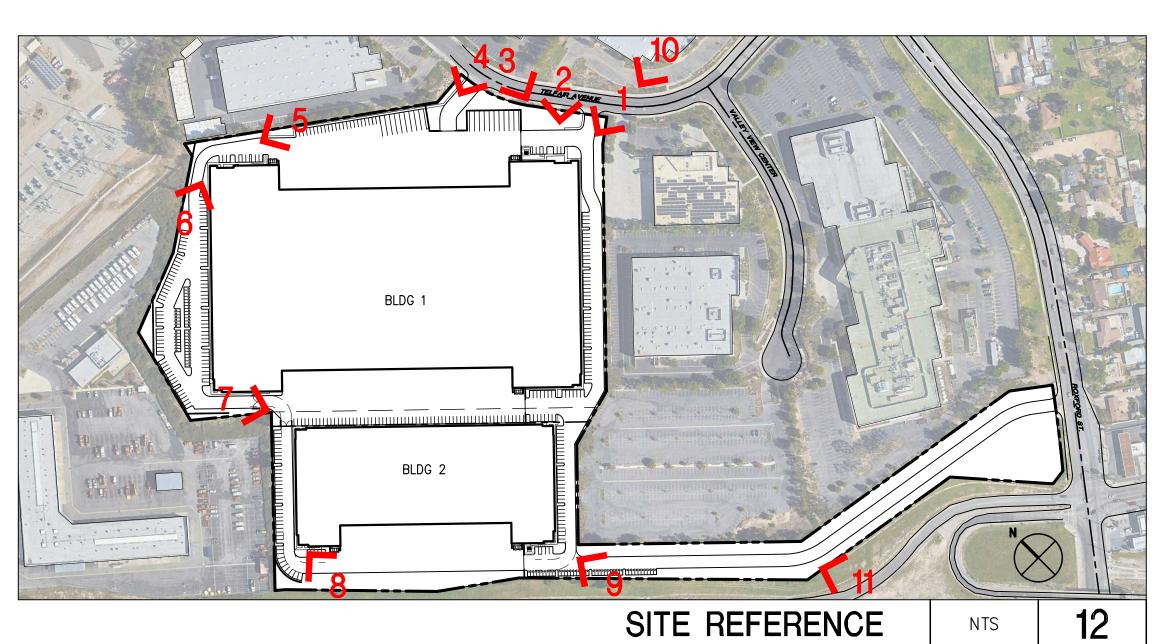


PROJECT RENDERINGS

ALL DRAWINGS AND WRITTEN MATERIAL APPEARING HEREIN CONSTITUTE THE ORIGINAL AND UNPUBLISHED WORK OF THE ARCHITECT AND THE SAME MAY NOT BE DUPLICATED, USED OR DISCLOSED WITHOUT THE EXPRESS WRITTEN CONSENT OF THE ARCHITECT. © GAA ARCHITECTS. ALL RIGHTS RESERVED.

JOB NO:	XRP040.01	SHEET N
DATE:	7/28/21	
DRAWN:	GAA	
FILE NAME:	KRP040.01_T2	

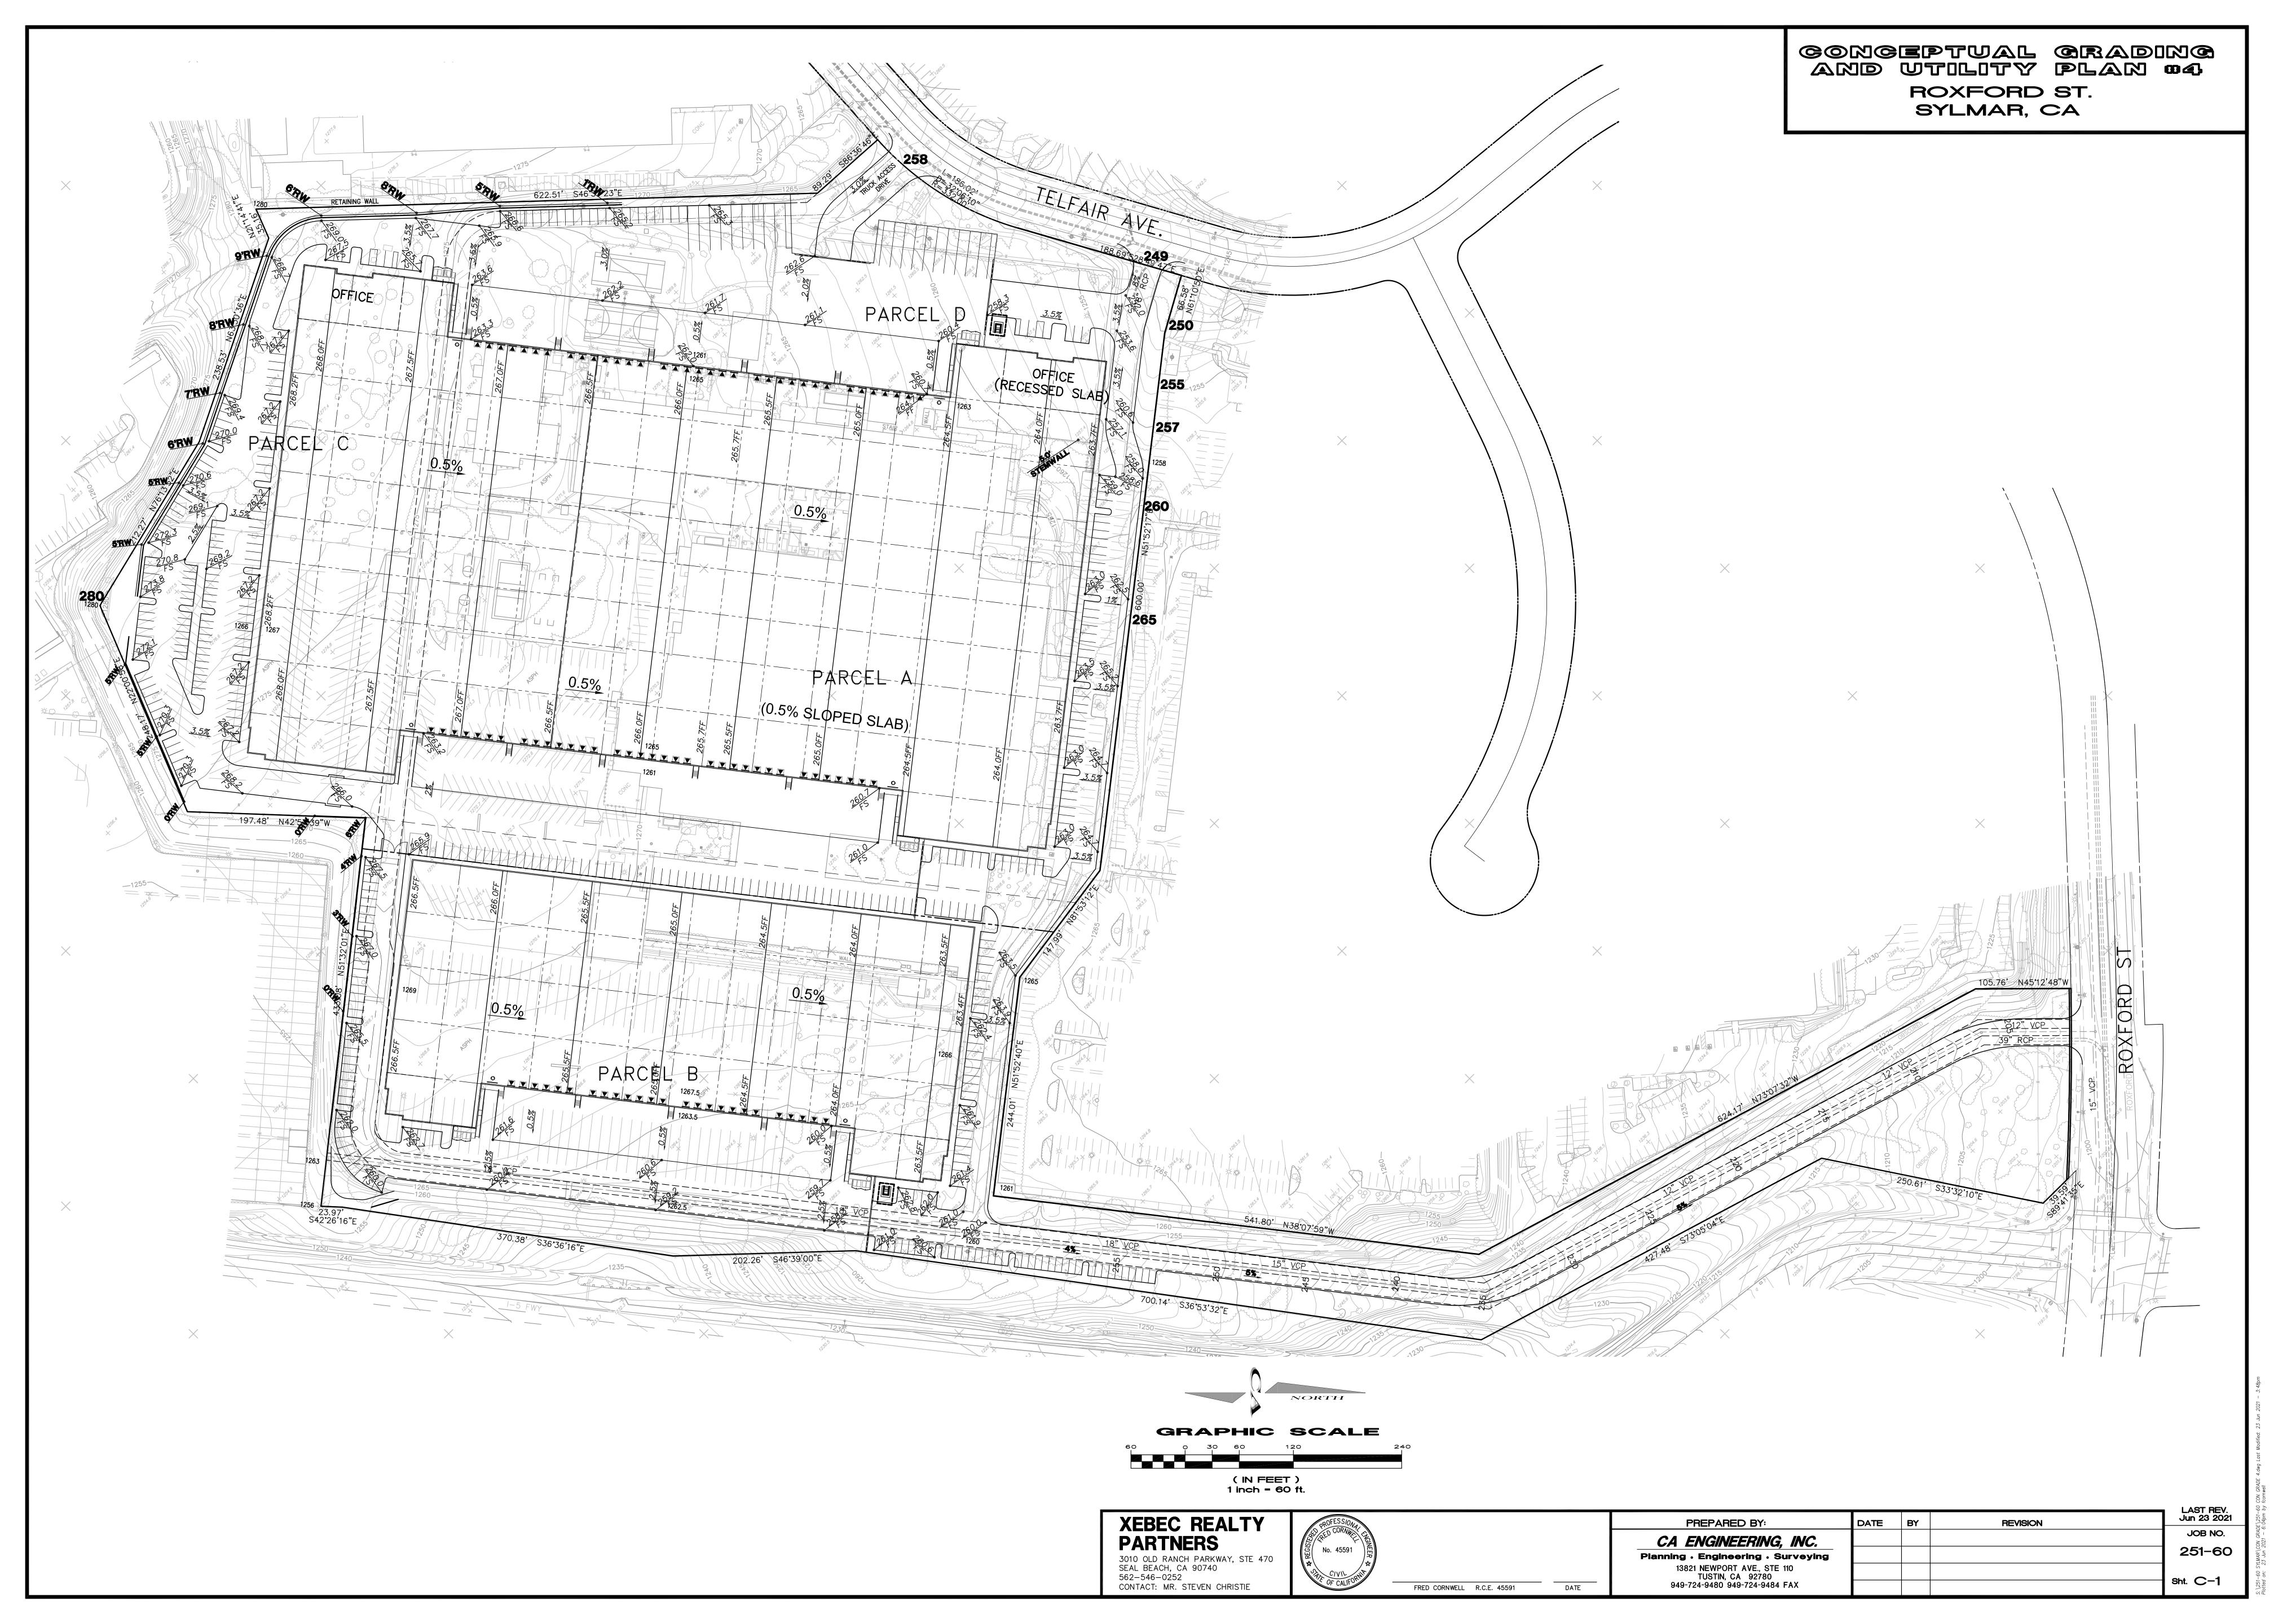

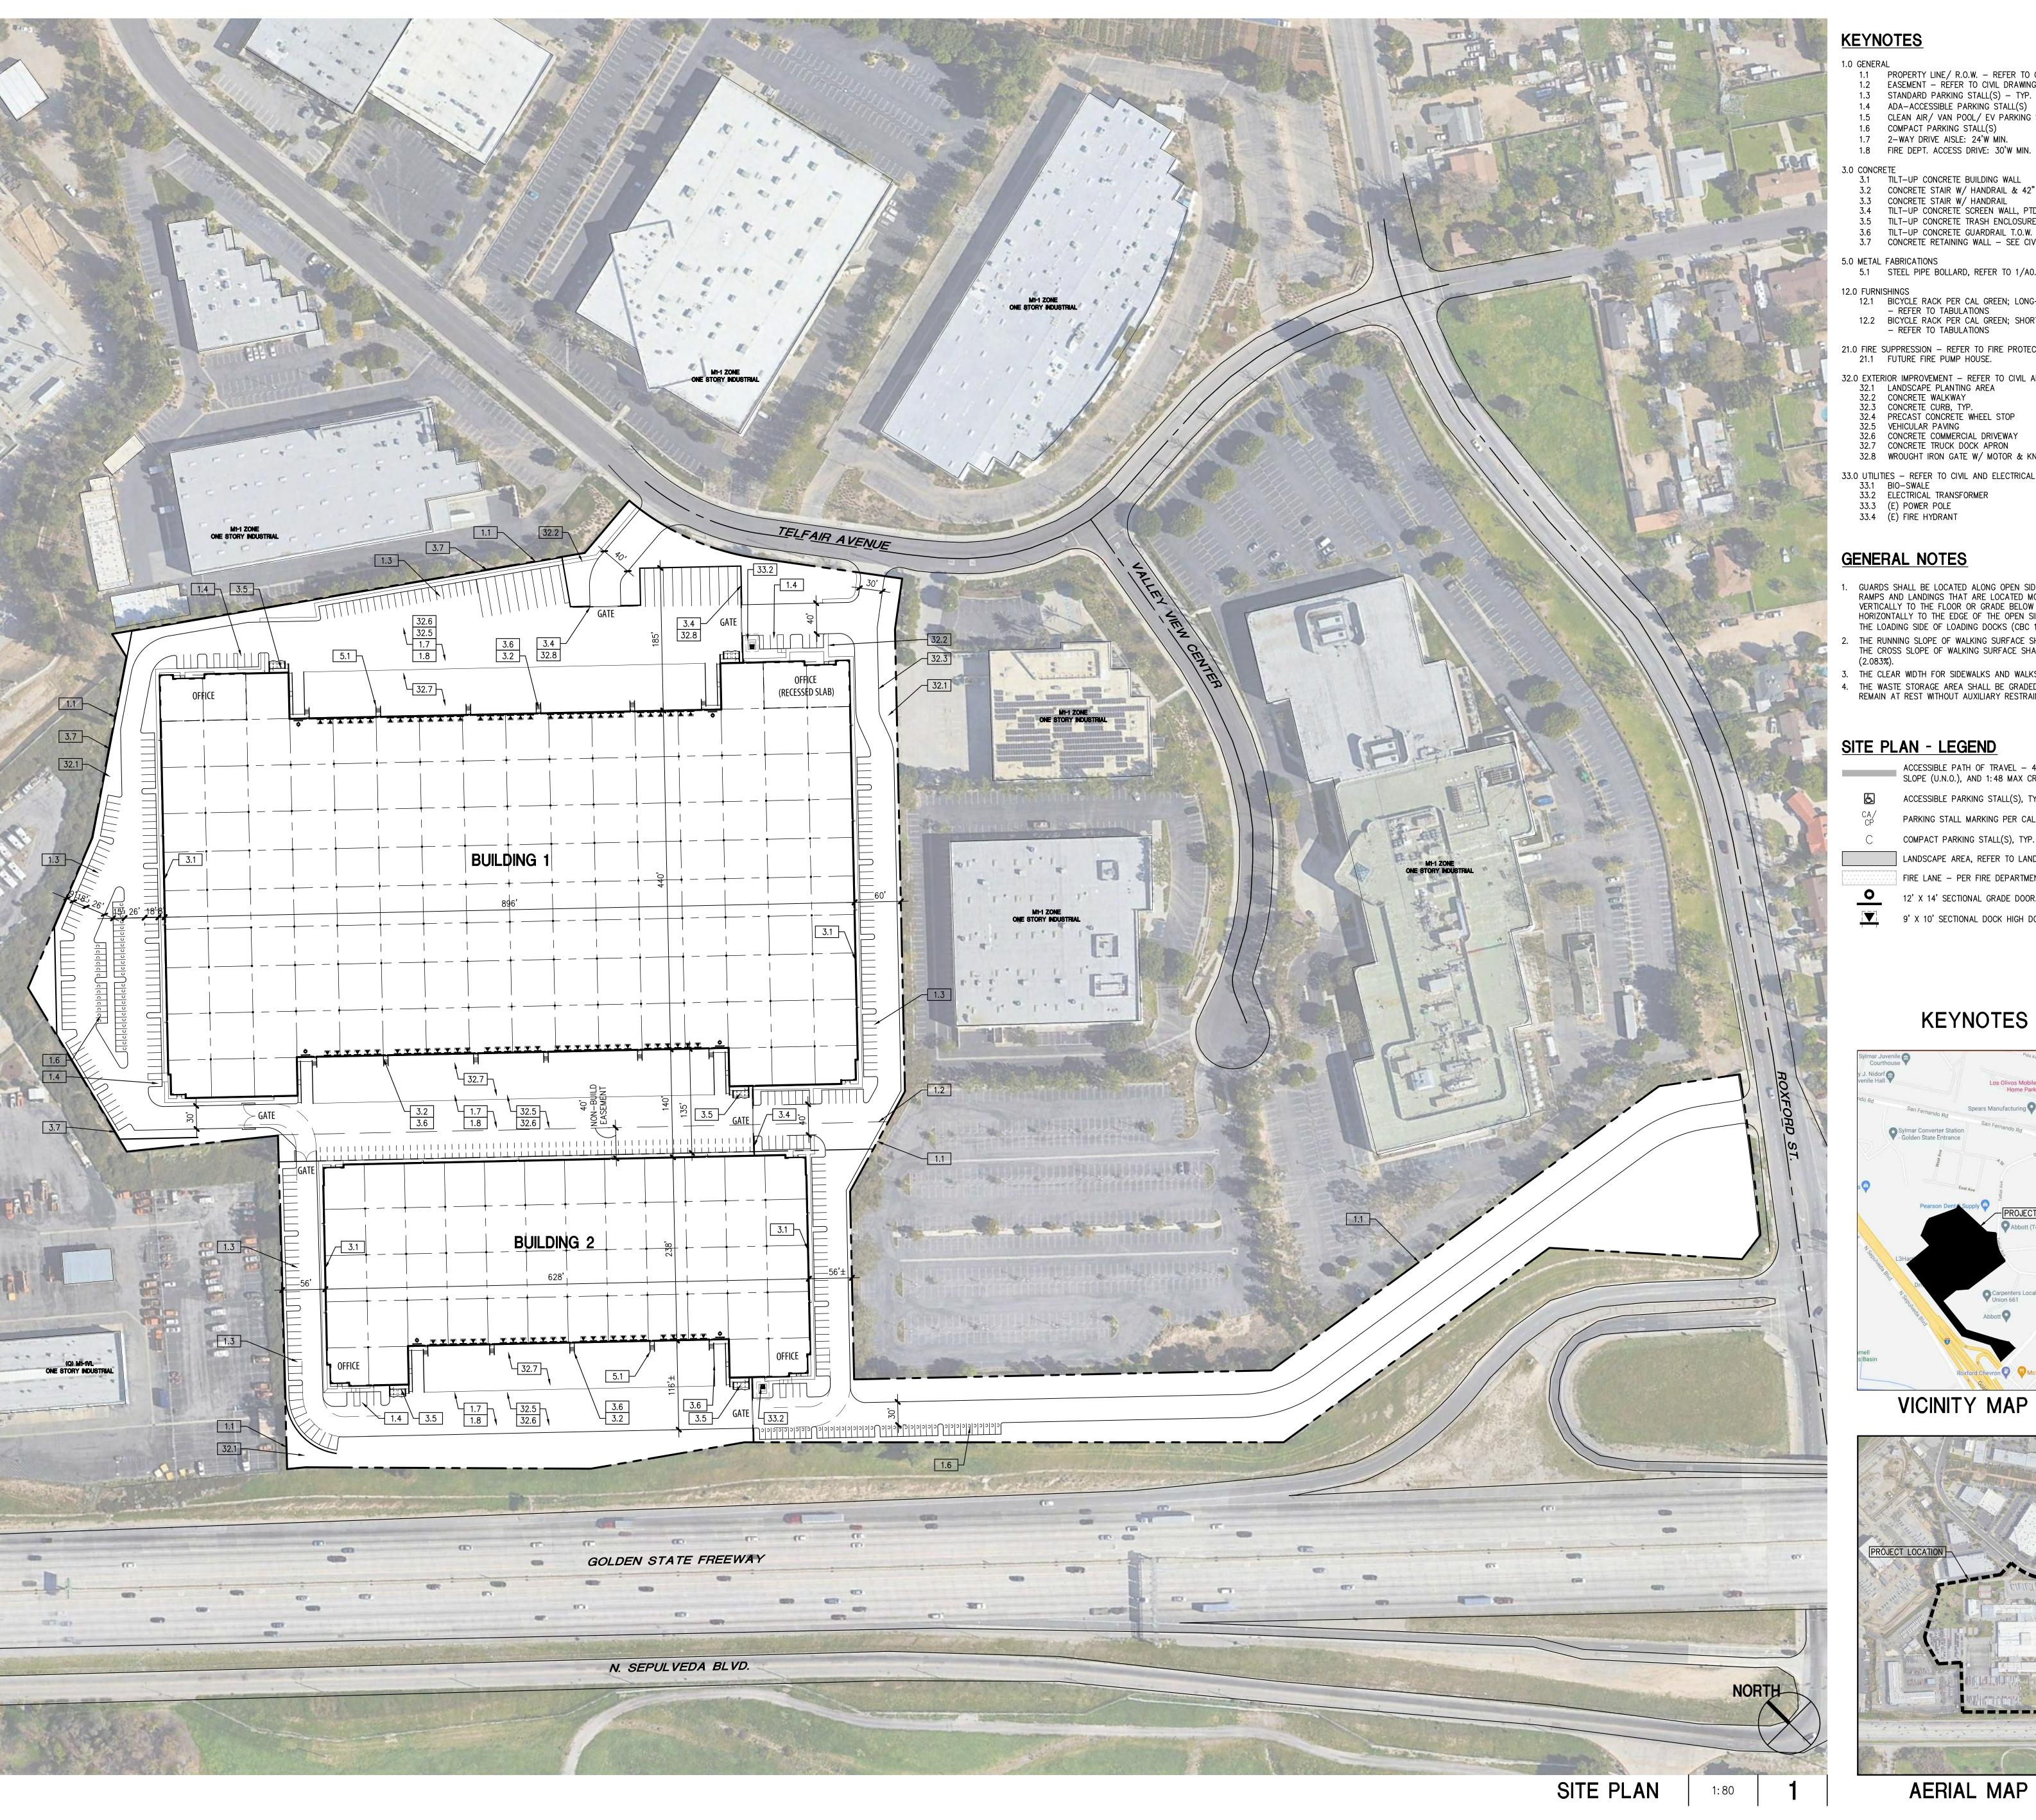

1.1 PROPERTY LINE/ R.O.W. — REFER TO CIVIL DRAWINGS
1.2 EASEMENT — REFER TO CIVIL DRAWINGS
1.3 STANDARD PARKING STALL(S) — TYP.

1.4 ADA-ACCESSIBLE PARKING STALL(S) 1.5 CLEAN AIR/ VAN POOL/ EV PARKING STALL(S) PER CALGREEN 5.106.5.2

1.6 COMPACT PARKING STALL(S)

1.7 2-WAY DRIVE AISLE: 24'W MIN. 1.8 FIRE DEPT. ACCESS DRIVE: 30'W MIN.

3.1 TILT-UP CONCRETE BUILDING WALL

3.2 CONCRETE STAIR W/ HANDRAIL & 42" GUARDRAIL 3.3 CONCRETE STAIR W/ HANDRAIL 3.4 TILT-UP CONCRETE SCREEN WALL, PTD.

3.5 TILT-UP CONCRETE TRASH ENCLOSURE, 6' TALL TYP. 3.6 TILT-UP CONCRETE GUARDRAIL T.O.W. 42" ABOVE HIGH SIDE 3.7 CONCRETE RETAINING WALL — SEE CIVIL

5.0 METAL FABRICATIONS 5.1 STEEL PIPE BOLLARD, REFER TO 1/A0.2

12.1 BICYCLE RACK PER CAL GREEN; LONG-TERM 5% OF EMPLOYEE PARKING REFER TO TABULATIONS

12.2 BICYCLE RACK PER CAL GREEN; SHORT-TERM 5% OF VISITOR PARKING
- REFER TO TABULATIONS

21.0 FIRE SUPPRESSION — REFER TO FIRE PROTECTION DRAWINGS 21.1 FUTURE FIRE PUMP HOUSE.

32.0 EXTERIOR IMPROVEMENT — REFER TO CIVIL AND LANDSCAPE U.N.O. 32.1 LANDSCAPE PLANTING AREA

32.2 CONCRETE WALKWAY 32.3 CONCRETE CURB, TYP.

32.4 PRECAST CONCRETE WHEEL STOP 32.5 VEHICULAR PAVING

32.6 CONCRETE COMMERCIAL DRIVEWAY

32.7 CONCRETE TRUCK DOCK APRON 32.8 WROUGHT IRON GATE W/ MOTOR & KNOX PADLOCK - 8' TALL

33.0 UTILITIES — REFER TO CIVIL AND ELECTRICAL 33.1 BIO—SWALE 33.2 ELECTRICAL TRANSFORMER

33.3 (E) POWER POLE 33.4 (E) FIRE HYDRANT

#### **GENERAL NOTES**

GUARDS SHALL BE LOCATED ALONG OPEN SIDE OF WALKING SURFACES, STAIRS, RAMPS AND LANDINGS THAT ARE LOCATED MORE THAN 30 INCHES MEASURED VERTICALLY TO THE FLOOR OR GRADE BELOW AT ANY POINT WITHIN 36 INCHES HORIZONTALLY TO THE EDGE OF THE OPEN SIDE. GUARDS ARE NOT REQUIRED ON THE LOADING SIDE OF LOADING DOCKS (CBC 1013.2).

THE RUNNING SLOPE OF WALKING SURFACE SHALL NOT BE STEEPER THAN 1:20 (5%). THE CROSS SLOPE OF WALKING SURFACE SHALL NOT BE STEEPER THAN 1:48 3. THE CLEAR WIDTH FOR SIDEWALKS AND WALKS SHALL BE 48 INCHES MINIMUM.

4. THE WASTE STORAGE AREA SHALL BE GRADED SO THAT STORAGE CONTAINERS REMAIN AT REST WITHOUT AUXILIARY RESTRAINING DEVICES.

#### SITE PLAN - LEGEND

ACCESSIBLE PATH OF TRAVEL - 4' WIDE MINIMUM - 1:20 MAX RUNNING SLOPE (U.N.O.), AND 1:48 MAX CROSS SLOPE


ACCESSIBLE PARKING STALL(S), TYP.

PARKING STALL MARKING PER CALGREEN CLEAN AIR/VANPOOL/EV, TYP.

COMPACT PARKING STALL(S), TYP. LANDSCAPE AREA, REFER TO LANDSCAPE DRAWINGS

FIRE LANE - PER FIRE DEPARTMENT REQUIREMENTS

12' X 14' SECTIONAL GRADE DOOR. REFER TO ELEVATIONS 9' X 10' SECTIONAL DOCK HIGH DOOR. REFER TO ELEVATIONS

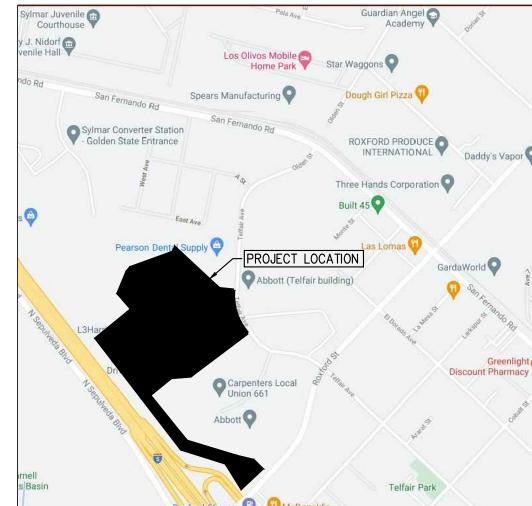

VICINITY MAP



OVERALL SITE PLAN PROJECT TABULATIONS

NO. DESCRIPTION

↑ PROGRESS SET

ALL DRAWINGS AND WRITTEN MATERIAL APPEARING HEREIN CONSTITUTE THE ORIGINAL AND UNPUBLISHED WORK OF THE ARCHITECT AND THE SAME MAY NOT BE DUPLICATED, USED OR DISCLOSED WITHOUT THE EXPRESS WRITTEN CONSENT OF THE ARCHITECT. (c) GAA ARCHITECTS. ALL RIGHTS RESERVED.

ARCHITECTS

8811 Research Drive,

RD ST 91342

OA

DEVEL ROXFC

Suite 200, Irvine, CA 92618

T: 949 474 1775 F: 949 553 9133

JOB NO:	XRP040.01	SHEET NO
DATE:	7/28/21	
DRAWN:	GAA	/
FII F NAME:		

## SITE INFORMATION

2604-001-001, 2604-001-002, 2604-001-003 2604-001-004

#### TENTATIVE PARCEL MAP TENTATIVE PARCEL MAP NO.

LEGAL DESCRIPTION: SEE CIVIL

#### LAND USE / ZONING: EXISTING/PROPOSED GENERAL PLAN:

LIMITED MANUFACTURING EXISTING/PROPOSED ZONING: EXISTING LAND USE: WAREHOUSE CODE ANALYSIS:

#### 2013 CBC CODE BUILDING OCCUPANCY: B, S CONSTRUCTION TYPE: FIRE SPRINKLERS (AUTOMATIC): YES

ZONING ANALYSIS: MAX COVERAGE/FAR: REQ. LANDSCAPING:

## MAX. BLDG HEIGHT: PARKING/LOADING

9'x18' STANDARD STALL: COMPACT STALL: 40% @ 7'-6"X15' MIN. AISLE: 26' LANES

#### SITE PLAN & CITY NOTES

- THE PROPERTY IS NOT WITHIN A SPECIFIC PLAN. THIS AREA IS NOT SUBJECT TO LIQUEFACTION OR OTHER GEOLOGIC HAZARDS WITHIN A SPECIAL STUDIES ZONE. THIS PROPERTY IS NOT SUBJECT TO OVERFLOW, INUNDATION, OR
- FLOOD HAZARD. SUBSURFACE SEPTIC SEWAGE IS NOT INTENDED FOR THIS SITE. THE PROPERTY DOES NOT CONTAIN ANY FLAMMABLE/COMBUSTIBLE MATERIALS OR WASTE.
- OF THE CIVIL PACKAGE. LOADING SPACES WILL BE PAVED WITH CONCRETE. SERVICE GATES WILL BE MANUALLY OPERATED W/ KNOX PAD LOCK. SIGN PROGRAM WILL BE UNDER SEPARATED PERMIT.
- NO ABOVE/UNDERGROUND TANKS ARE PROVIDED. SITE PLAN SHALL MEET ALL ENGINEERING & NPDES REQUIREMENTS.

#### FIRE DEPARTMENT NOTES: FIRE DEPARTMENT ACCESS SHALL COMPLY WITH FIRE DEPARTMENT FIRE PROTECTION STANDARDS.

#### CALGREEN NOTES:

- PROJECT SITE IS LARGER THAN ONE ACRE A STORM WATER POLLUTION PLAN IS REQUIRED (CG 5.106.1).
- FEET OF BUILDING ENTRANCES, FOR A MINIMUM OF 5% NEW VISITOR VEHICULAR PARKING (CG 5.106.4.1). IN BUILDINGS WITH OVER 10 TENANT-OCCUPANTS, SECURE.
- LONG-TERM BICYCLE ENCLOSURES OR LOCKERS SHALL BE PROVIDED ON-SITE, FOR A MINIMUM OF 5% NEW TENANT VEHICULAR PARKING (CG 5.106.5.1). COMPLIANCE WITH THIS SECTION WILL BE PROVIDED IN EACH PERMIT FOR TENANT IMPROVEMENT INDOORS IN AMOUNTS

- PROPORTIONAL TO THE PARKING REQUIRED FOR EACH TENANT IMPROVEMENT. 'CLEAN AIR' PARKING SPACES SHALL BE PROVIDED ON SITE FOR CARPOOLS & FUEL-EFFICIENT VEHICLES, FOR A MINIMUM NUMBER OF SPACES PROPORTIONAL TO REQUIRED VEHICLE PARKING PER CALGREEN TABLE (CG5.106.5.2). LIGHTING DESIGN SHALL LIMIT GLARE AND UPLIGHT AND COMPLY
- WITH LOCAL CODES AND CALGREEN (CG 5.106.8). THIS PROJECT'S PLUMBING FIXTURES SHALL BE 20% WATER-CONSERVING (CG 5.303.2). BEING A SHELL BUILDING, COMPLIANCE WITH THIS SECTION WILL BE PROVIDED IN EACH PERMIT FOR TENANT IMPROVEMENT. THE PROPERTY'S WATER QUALITY FEATURES ARE SHOWN AS PART
   FOR PROJECTS WITH OVER 1,000 S.F. OF LANDSCAPING, SEPARATE SUBMETERS OR METERING DEVICES SHALL BE INSTALLED FOR OUTDOOR POTABLE WATER USE, AND IRRIGATION SYSTEM SHALL
  - HAVE WEATHER- OR SOIL MOISTURE-BASED AUTOMATIC CONTROLLERS (CG 5.304.2&3). A CONSTRUCTION WASTE MANAGEMENT PLAN SHALL BE DEVELOPED, DEMONSTRATING A MINIMUM OF 50% RECYCLING AND/OR SALVAGING OF NON-HAZARDOUS CONSTRUCTION WASTE AND COMPLYING WITH
  - CALGREEN REQUIREMENTS (CG 5.408.1). 100% OF LAND-CLEARED SOILS AND VEGETATION SHALL BE REUSED OR RECYCLED (CG 5.408.3). PER SECTION 5.410.2, EXCÉPTIONS 1 & 2, COMMISSIONING IS NOT REQUIRED FOR DRY STORAGE WAREHOUSES OR AREAS USED FOR

OFFICES LESS THAN 10,000 SF IN DRY STORAGE WAREHOUSES. (CG

 VISITOR BICYCLE PARKING RACKS SHALL BE PROVIDED WITHIN 200
 ALL CONSTRUCTION MATERIALS TO COMPLY WITH THE VOC AND TOXIN LIMITS LISTED (CG 5.504). SMOKING SHALL BE PROHIBITED WITHIN 25 FEET OF BUILDING ENTRIES, AIR INTAKES, AND OPERABLE WINDOWS (CG 5.504.7).

> PROJECT INFO 6

SITE AREA BUILDING 1 BUILDING 2 Site Area (SF) 428,499 1,216,764 27.93 Site Area (Acres) 18.10 9.84 **BUILDING AREA** BUILDING 1 BUILDING 2 Ground Floor Office 417,200 154,000 Warehouse 159,000 **Total Building Footprint** 430,000 12.800 5,000 17.800 Mezzanine TOTAL BUILDING AREA 442,800 164,000 COVERAGE 54.6% FAR 56.2% 38.3% 49.9% PARKING REQUIRED BUILDING 1 BUILDING 2 Office Warehouse 0 - 10,000 sf 1/500 10,000 sf + 1/5000 TOTAL PARKING REQUIRED 294 PARKING PROVIDED **PARKING RATIO** 0.6/1000 0.6/1000 0.6/1000 **DOCK DOORS GRADE DOORS** 

PROJECT TABULATIONS

SITE PLAN

TRAILER STALLS

#### 1.0 GENERAL 1.1 PROPERTY LINE / R.O.W. - REFER TO CIVIL DRAWINGS 1.2 EASEMENT - REFER TO CIVIL DRAWINGS 1.3 STANDARD PARKING STALL(S) - TYP.

1.4 ADA-ACCESSIBLE PARKING STALL(S) 1.5 CLEAN AIR / VAN POOL / EV PARKING STALL(S) PER CALGREEN 5.106.5.2 1.6 COMPACT PARKING STALL(S)

1.7 2-WAY DRIVE AISLE: 24'W MIN.

1.8 FIRE DEPT. ACCESS DRIVE: 30'W MIN.

3.2 CONCRETE STAIR W/ HANDRAIL & 42" GUARDRAIL 3.3 CONCRETE STAIR W/ HANDRAIL 3.4 TILT-UP CONCRETE SCREEN WALL, PTD. 3.5 TILT-UP CONCRETE TRASH ENCLOSURE, 6' TALL TYP. 3.6 TILT-UP CONCRETE GUARDRAIL T.O.W. 42" ABOVE HIGH SIDE

3.1 TILT-UP CONCRETE BUILDING WALL

3.7 CONCRETE RETAINING WALL — SEE CIVIL 5.0 METAL FABRICATIONS 5.1 STEEL PIPE BOLLARD, REFER TO 1/A0.2

12.1 BICYCLE RACK PER CAL GREEN; LONG-TERM 5% OF EMPLOYEE PARKING REFER TO TABULATIONS 12.2 BICYCLE RACK PER CAL GREEN; SHORT-TERM 5% OF VISITOR PARKING

21.0 FIRE SUPPRESSION - REFER TO FIRE PROTECTION DRAWINGS

21.1 FUTURE FIRE PUMP HOUSE. 32.0 EXTERIOR IMPROVEMENT - REFER TO CIVIL AND LANDSCAPE U.N.O.

32.1 LANDSCAPE PLANTING AREA 32.2 CONCRETE WALKWAY

32.3 CONCRETE CURB, TYP. 32.4 PRECAST CONCRETE WHEEL STOP 32.5 VEHICULAR PAVING

- REFER TO TABULATIONS

32.6 CONCRETE COMMERCIAL DRIVEWAY 32.7 CONCRETE TRUCK DOCK APRON 32.8 WROUGHT IRON GATE W/ MOTOR & KNOX PADLOCK - 8' TALL

33.0 UTILITIES - REFER TO CIVIL AND ELECTRICAL

33.1 BIO-SWALE 33.2 ELECTRICAL TRANSFORMER

33.3 (E) POWER POLE

33.4 (E) FIRE HYDRANT

#### **GENERAL NOTES**

GUARDS SHALL BE LOCATED ALONG OPEN SIDE OF WALKING SURFACES, STAIRS, RAMPS AND LANDINGS THAT ARE LOCATED MORE THAN 30 INCHES MEASURED VERTICALLY TO THE FLOOR OR GRADE BELOW AT ANY POINT WITHIN 36 INCHES HORIZONTALLY TO THE EDGE OF THE OPEN SIDE. GUARDS ARE NOT REQUIRED ON THE LOADING SIDE OF LOADING DOCKS (CBC 1013.2).

THE CROSS SLOPE OF WALKING SURFACE SHALL NOT BE STEEPER THAN 1:48 3. THE CLEAR WIDTH FOR SIDEWALKS AND WALKS SHALL BE 48 INCHES MINIMUM.

THE RUNNING SLOPE OF WALKING SURFACE SHALL NOT BE STEEPER THAN 1:20 (5%).

4. THE WASTE STORAGE AREA SHALL BE GRADED SO THAT STORAGE CONTAINERS REMAIN AT REST WITHOUT AUXILIARY RESTRAINING DEVICES.

## SITE PLAN - LEGEND

ACCESSIBLE PATH OF TRAVEL - 4' WIDE MINIMUM - 1:20 MAX RUNNING SLOPE (U.N.O.), AND 1:48 MAX CROSS SLOPE


PARKING STALL MARKING PER CALGREEN CLEAN AIR/VANPOOL/EV. TYP COMPACT PARKING STALL(S), TYP.

9' X 10' SECTIONAL DOCK HIGH DOOR. REFER TO ELEVATIONS

LANDSCAPE AREA, REFER TO LANDSCAPE DRAWINGS

FIRE LANE - PER FIRE DEPARTMENT REQUIREMENTS 12' X 14' SECTIONAL GRADE DOOR. REFER TO ELEVATIONS

## **KEYNOTES**

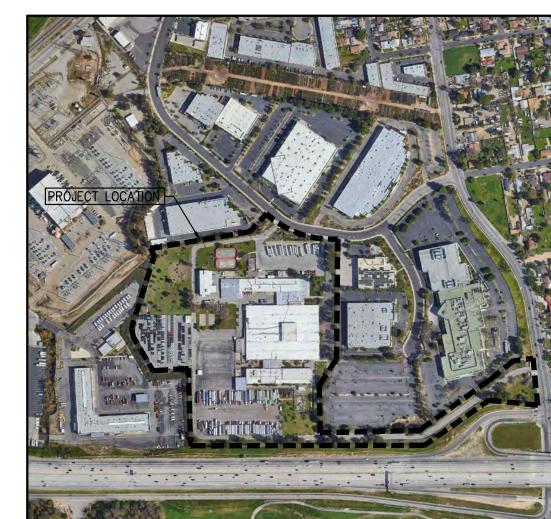

AERIAL MAP

**ENLARGED SITE PLAN BUILDING 1** 

ALL DRAWINGS AND WRITTEN MATERIAL APPEARING HEREIN CONSTITUTE THE ORIGINAL AND UNPUBLISHED WORK OF THE ARCHITECT AND THE SAME MAY NOT BE DUPLICATED, USED OR DISCLOSED WITHOUT THE EXPRESS WRITTEN CONSENT OF THE ARCHITECT. (c) GAA ARCHITECTS. ALL RIGHTS RESERVED.

XRP040.01 7/28/21

A1.2 FILE NAME: XPR040.01\_A1.2

ARCHITECTS

8811 Research Drive,

Irvine, CA 92618

T: 949 474 1775

F: 949 553 9133


Suite 200,

TREET BLDG

RD 913,

O 4

RO AR,

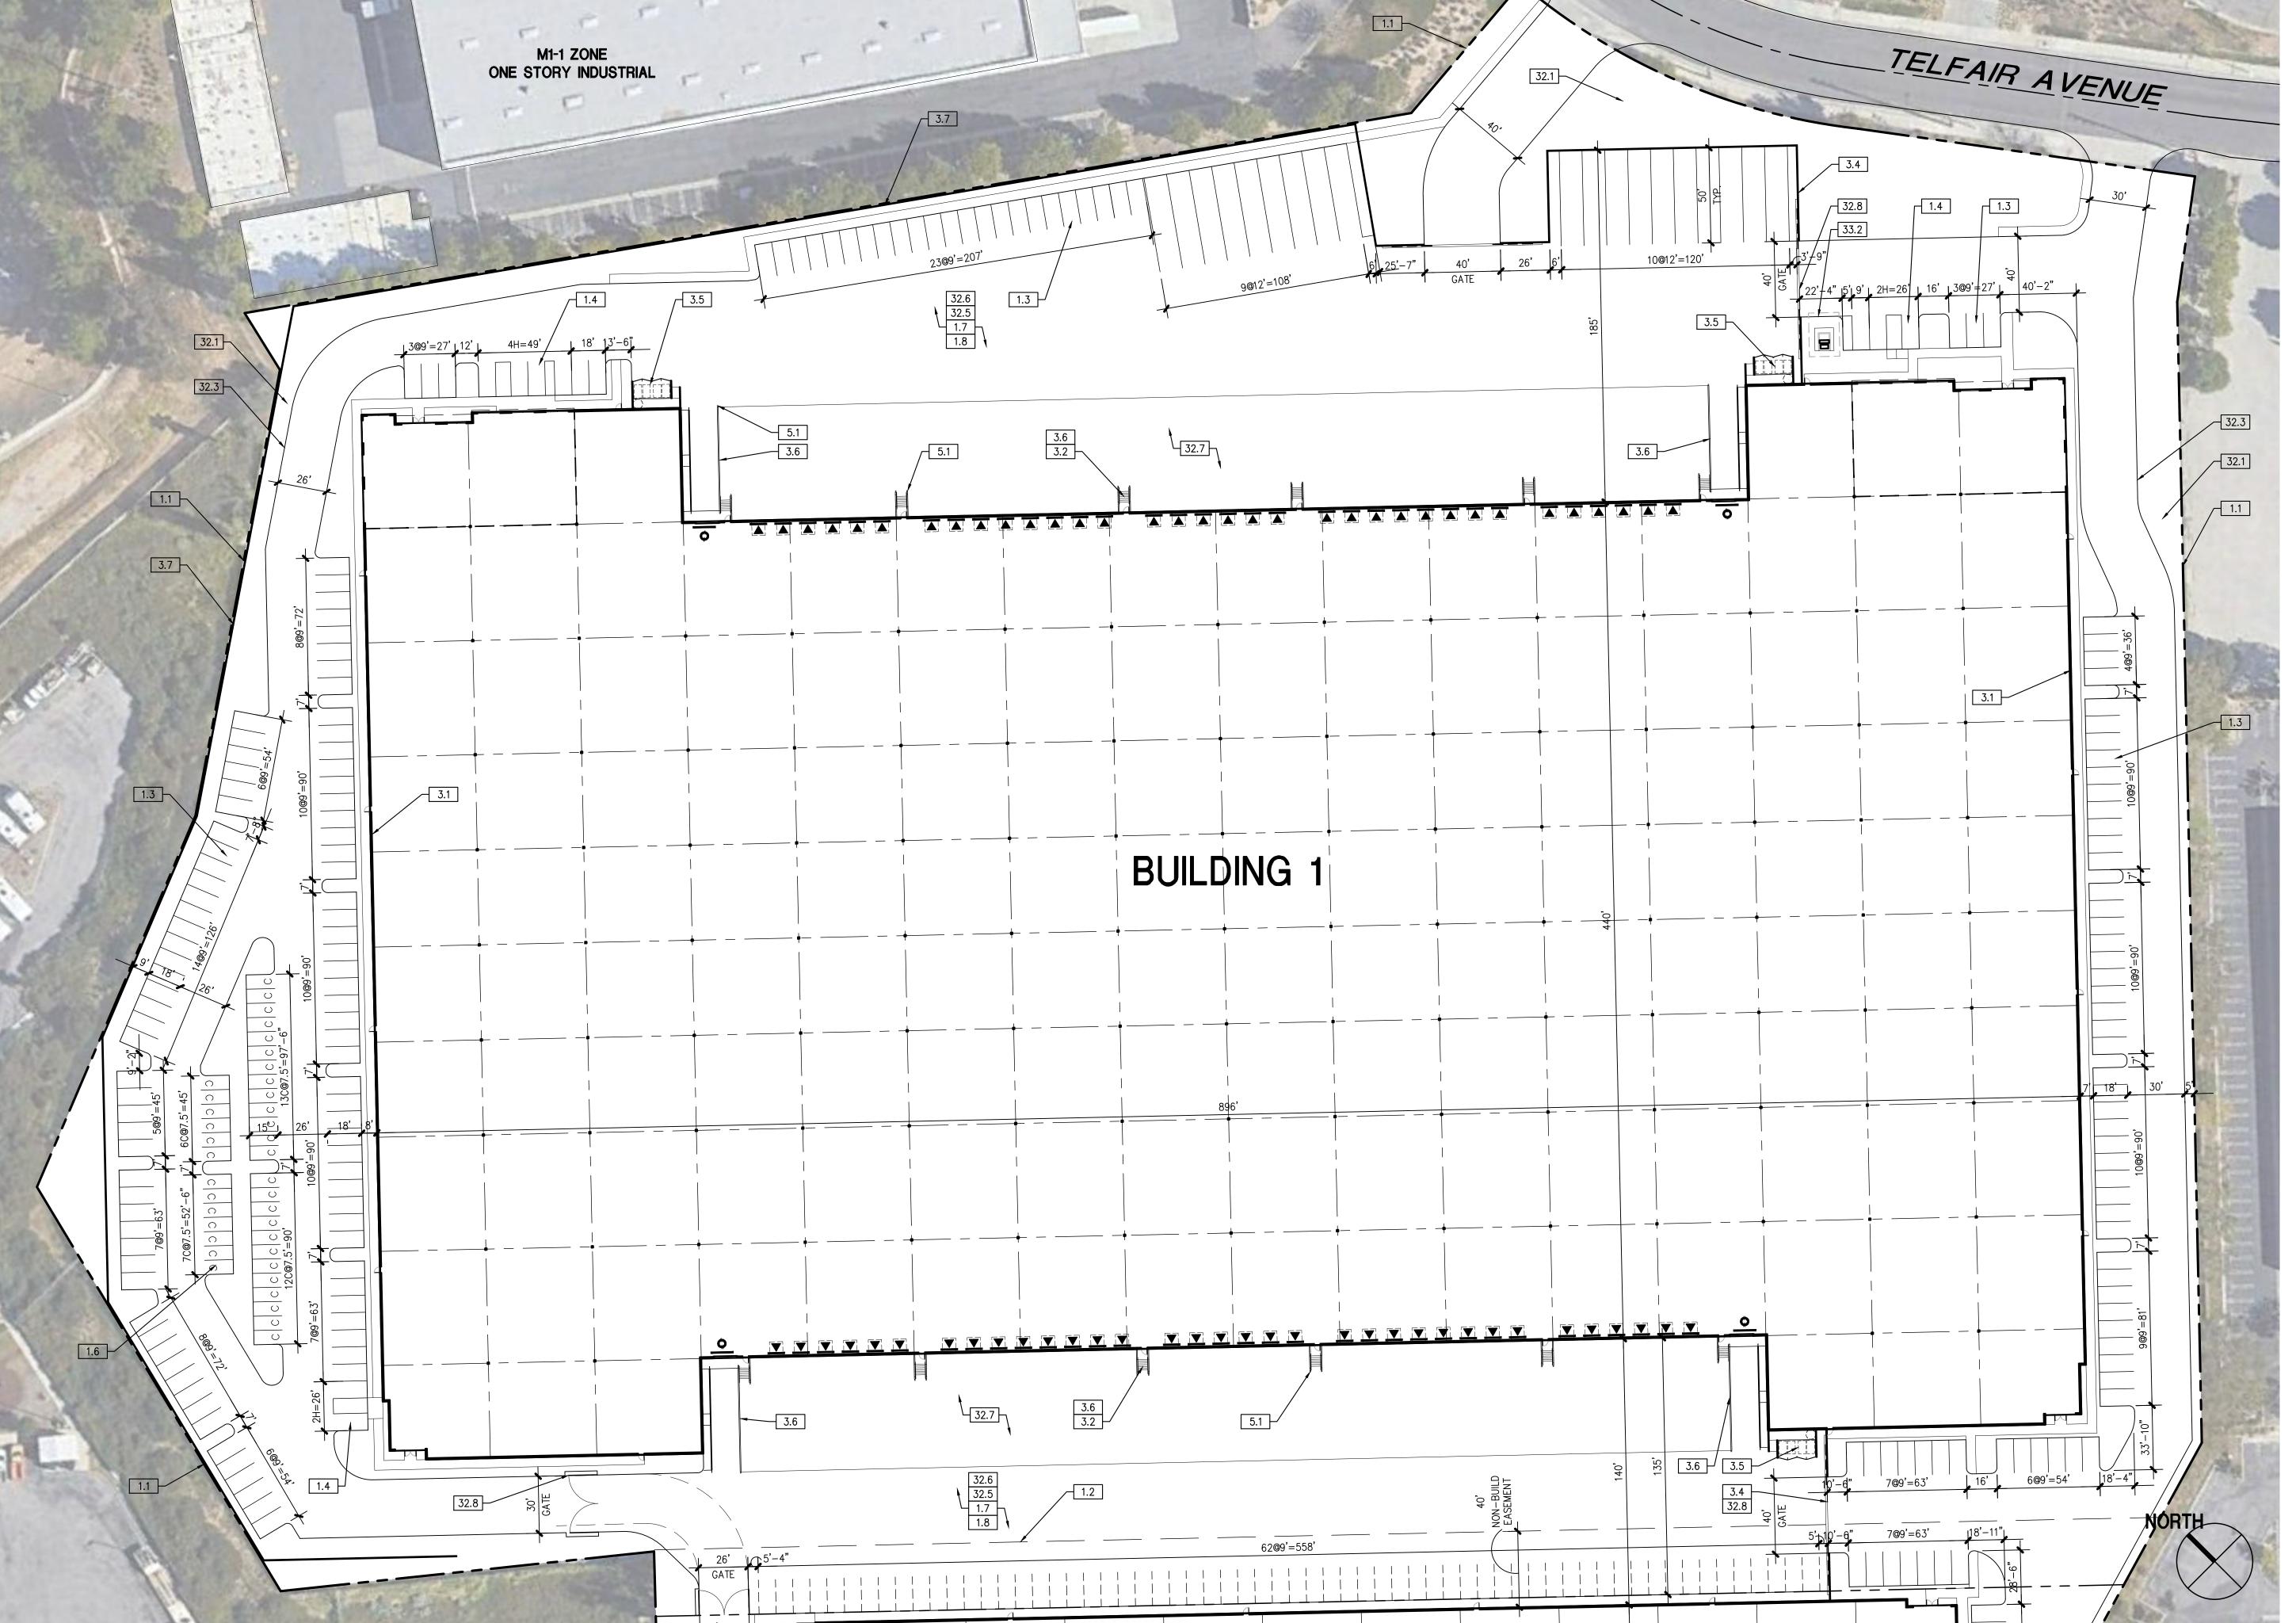

#### TENTATIVE PARCEL MAP TENTATIVE PARCEL MAP NO.

LEGAL DESCRIPTION:

SEE CIVIL

LAND USE / ZONING: EXISTING/PROPOSED GENERAL PLAN:

LIMITED MANUFACTURING EXISTING/PROPOSED ZONING: EXISTING LAND USE: WAREHOUSE CODE ANALYSIS:

2013 CBC CODE BUILDING OCCUPANCY: B, S CONSTRUCTION TYPE: FIRE SPRINKLERS (AUTOMATIC): YES

ZONING ANALYSIS: MAX COVERAGE/FAR: -% REQ. LANDSCAPING: MAX. BLDG HEIGHT:

PARKING/LOADING 9'x18' STANDARD STALL: COMPACT STALL: 40% @ 7'-6"X15' MIN. AISLE: 26' LANES

#### SITE PLAN & CITY NOTES

### THE PROPERTY IS NOT WITHIN A SPECIFIC PLAN.

- THIS AREA IS NOT SUBJECT TO LIQUEFACTION OR OTHER GEOLOGIC HAZARDS WITHIN A SPECIAL STUDIES ZONE. THIS PROPERTY IS NOT SUBJECT TO OVERFLOW, INUNDATION, OR
- FLOOD HAZARD. SUBSURFACE SEPTIC SEWAGE IS NOT INTENDED FOR THIS SITE. THE PROPERTY DOES NOT CONTAIN ANY FLAMMABLE/COMBUSTIBLE
- MATERIALS OR WASTE. OF THE CIVIL PACKAGE.
- LOADING SPACES WILL BE PAVED WITH CONCRETE. SERVICE GATES WILL BE MANUALLY OPERATED W/ KNOX PAD LOCK. SIGN PROGRAM WILL BE UNDER SEPARATED PERMIT.
- NO ABOVE/UNDERGROUND TANKS ARE PROVIDED. SITE PLAN SHALL MEET ALL ENGINEERING & NPDES REQUIREMENTS.

#### FIRE DEPARTMENT NOTES:

 FIRE DEPARTMENT ACCESS SHALL COMPLY WITH FIRE DEPARTMENT FIRE PROTECTION STANDARDS.

#### CALGREEN NOTES:

- PROJECT SITE IS LARGER THAN ONE ACRE A STORM WATER POLLUTION PLAN IS REQUIRED (CG 5.106.1).
- FEET OF BUILDING ENTRANCES, FOR A MINIMUM OF 5% NEW VISITOR VEHICULAR PARKING (CG 5.106.4.1). IN BUILDINGS WITH OVER 10 TENANT-OCCUPANTS. SECURE.
- LONG-TERM BICYCLE ENCLOSURES OR LOCKERS SHALL BE PROVIDED ON-SITE, FOR A MINIMUM OF 5% NEW TENANT VEHICULAR PARKING (CG 5.106.5.1). COMPLIANCE WITH THIS SECTION WILL BE PROVIDED IN EACH PERMIT FOR TENANT IMPROVEMENT INDOORS IN AMOUNTS

- PROPORTIONAL TO THE PARKING REQUIRED FOR EACH TENANT IMPROVEMENT. 'CLEAN AIR' PARKING SPACES SHALL BE PROVIDED ON SITE FOR CARPOOLS & FUEL-EFFICIENT VEHICLES, FOR A MINIMUM NUMBER OF SPACES PROPORTIONAL TO REQUIRED VEHICLE PARKING PER CALGREEN TABLE (CG5.106.5.2). LIGHTING DESIGN SHALL LIMIT GLARE AND UPLIGHT AND COMPLY
- WITH LOCAL CODES AND CALGREEN (CG 5.106.8). THIS PROJECT'S PLUMBING FIXTURES SHALL BE 20% WATER-CONSERVING (CG 5.303.2). BEING A SHELL BUILDING, COMPLIANCE WITH THIS SECTION WILL BE PROVIDED IN EACH PERMIT FOR TENANT IMPROVEMENT.
- THE PROPERTY'S WATER QUALITY FEATURES ARE SHOWN AS PART
   FOR PROJECTS WITH OVER 1,000 S.F. OF LANDSCAPING, SEPARATE SUBMETERS OR METERING DÉVICES SHALL BE INSTALLED FOR OUTDOOR POTABLE WATER USE. AND IRRIGATION SYSTEM SHALL HAVE WEATHER- OR SOIL MOISTURE-BASED AUTOMATIC
  - CONTROLLERS (CG 5.304.2&3). A CONSTRUCTION WASTE MANAGEMENT PLAN SHALL BE DEVELOPED, DEMONSTRATING A MINIMUM OF 50% RECYCLING AND/OR SALVAGING OF NON-HAZARDOUS CONSTRUCTION WASTE AND COMPLYING WITH CALGREEN REQUIREMENTS (CG 5.408.1).
  - 100% OF LAND-CLEARED SOILS AND VEGETATION SHALL BE REUSED OR RECYCLED (CG 5.408.3). PER SECTION 5.410.2, EXCÉPTIONS 1 & 2, COMMISSIONING IS NOT REQUIRED FOR DRY STORAGE WAREHOUSES OR AREAS USED FOR OFFICES LESS THAN 10,000 SF IN DRY STORAGE WAREHOUSES. (CG
- VISITOR BICYCLE PARKING RACKS SHALL BE PROVIDED WITHIN 200
   ALL CONSTRUCTION MATERIALS TO COMPLY WITH THE VOC AND TOXIN LIMITS LISTED (CG 5.504). SMOKING SHALL BE PROHIBITED WITHIN 25 FEET OF BUILDING ENTRIES, AIR INTAKES, AND OPERABLE WINDOWS (CG 5.504.7).

PROJECT INFO

SITE AREA	<b>BUILDING 1</b>	BUILDING 2	TOTAL
Site Area (SF)	788,265	428,499	1,216,764
Site Area (Acres)	18.10	9.84	27.93
BUILDING AREA	BUILDING 1	BUILDING 2	TOTAL
Ground Floor Office	12,800	5,000	17,800
Warehouse	417,200	154,000	571,200
Total Building Footprint	430,000	159,000	589,000
Mezzanine	12,800	5,000	17,800
TOTAL BUILDING AREA	442,800	164,000	606,800
COVERAGE	54.6%	37.1%	48.4%
FAR	56.2%	38.3%	49.9%
PARKING REQUIRED	BUILDING 1	BUILDING 2	TOTAL
Office 1/500	51.2	20	71.2
\			
vvarenouse			
0 - 10,000 sf 1/500	20	20	40
	20 82	20 29	
•			40 111 <b>22</b> 2
0 - 10,000 sf 1/500 10,000 sf + 1/5000 TOTAL PARKING REQUIRED	82 1 <b>53</b>	29 <b>69</b>	111 222
0 - 10,000 sf 1/500 10,000 sf + 1/5000 TOTAL PARKING REQUIRED PARKING PROVIDED	82 153 294	29 <b>69</b> 116	111 222 410
0 - 10,000 sf 1/500 10,000 sf + 1/5000	82 1 <b>53</b>	29 <b>69</b>	111 222

PROJECT TABULATIONS

**GRADE DOORS** 

TRAILER STALLS

### **KEYNOTES** 1.0 GENERAL

## 1.1 PROPERTY LINE / R.O.W. - REFER TO CIVIL DRAWINGS

1.2 EASEMENT — REFER TO CIVIL DRAWINGS 1.3 STANDARD PARKING STALL(S) - TYP.

1.4 ADA-ACCESSIBLE PARKING STALL(S) 1.5 CLEAN AIR / VAN POOL / EV PARKING STALL(S) PER CALGREEN 5.106.5.2 1.6 COMPACT PARKING STALL(S)

1.7 2-WAY DRIVE AISLE: 24'W MIN. 1.8 FIRE DEPT. ACCESS DRIVE: 30'W MIN.

3.1 TILT-UP CONCRETE BUILDING WALL 3.2 CONCRETE STAIR W/ HANDRAIL & 42" GUARDRAIL 3.3 CONCRETE STAIR W/ HANDRAIL

3.4 TILT-UP CONCRETE SCREEN WALL, PTD. 3.5 TILT-UP CONCRETE TRASH ENCLOSURE, 6' TALL TYP. 3.6 TILT-UP CONCRETE GUARDRAIL T.O.W. 42" ABOVE HIGH SIDE 3.7 CONCRETE RETAINING WALL — SEE CIVIL

5.0 METAL FABRICATIONS 5.1 STEEL PIPE BOLLARD, REFER TO 1/A0.2

REFER TO TABULATIONS

12.1 BICYCLE RACK PER CAL GREEN; LONG-TERM 5% OF EMPLOYEE PARKING REFER TO TABULATIONS 12.2 BICYCLE RACK PER CAL GREEN; SHORT-TERM 5% OF VISITOR PARKING

21.0 FIRE SUPPRESSION - REFER TO FIRE PROTECTION DRAWINGS 21.1 FUTURE FIRE PUMP HOUSE.

32.0 EXTERIOR IMPROVEMENT - REFER TO CIVIL AND LANDSCAPE U.N.O.

32.1 LANDSCAPE PLANTING AREA 32.2 CONCRETE WALKWAY 32.3 CONCRETE CURB, TYP.

32.4 PRECAST CONCRETE WHEEL STOP 32.5 VEHICULAR PAVING 32.6 CONCRETE COMMERCIAL DRIVEWAY

32.7 CONCRETE TRUCK DOCK APRON 32.8 WROUGHT IRON GATE W/ MOTOR & KNOX PADLOCK - 8' TALL

33.0 UTILITIES - REFER TO CIVIL AND ELECTRICAL

33.1 BIO-SWALE

33.2 ELECTRICAL TRANSFORMER

33.3 (E) POWER POLE 33.4 (E) FIRE HYDRANT

#### **GENERAL NOTES**

1. GUARDS SHALL BE LOCATED ALONG OPEN SIDE OF WALKING SURFACES, STAIRS, RAMPS AND LANDINGS THAT ARE LOCATED MORE THAN 30 INCHES MEASURED VERTICALLY TO THE FLOOR OR GRADE BELOW AT ANY POINT WITHIN 36 INCHES HORIZONTALLY TO THE EDGE OF THE OPEN SIDE. GUARDS ARE NOT REQUIRED ON THE LOADING SIDE OF LOADING DOCKS (CBC 1013.2).

2. THE RUNNING SLOPE OF WALKING SURFACE SHALL NOT BE STEEPER THAN 1:20 (5%). THE CROSS SLOPE OF WALKING SURFACE SHALL NOT BE STEEPER THAN 1:48

3. THE CLEAR WIDTH FOR SIDEWALKS AND WALKS SHALL BE 48 INCHES MINIMUM. 4. THE WASTE STORAGE AREA SHALL BE GRADED SO THAT STORAGE CONTAINERS REMAIN AT REST WITHOUT AUXILIARY RESTRAINING DEVICES.

## SITE PLAN - LEGEND


ACCESSIBLE PATH OF TRAVEL - 4' WIDE MINIMUM - 1:20 MAX RUNNING SLOPE (U.N.O.), AND 1:48 MAX CROSS SLOPE


ACCESSIBLE PARKING STALL(S), TYP.

PARKING STALL MARKING PER CALGREEN CLEAN AIR/VANPOOL/EV, TY

ANDSCAPE AREA, REFER TO LANDSCAPE DRAWINGS FIRE LANE - PER FIRE DEPARTMENT REQUIREMENTS

12' X 14' SECTIONAL GRADE DOOR. REFER TO ELEVATIONS 9' X 10' SECTIONAL DOCK HIGH DOOR. REFER TO ELEVATIONS

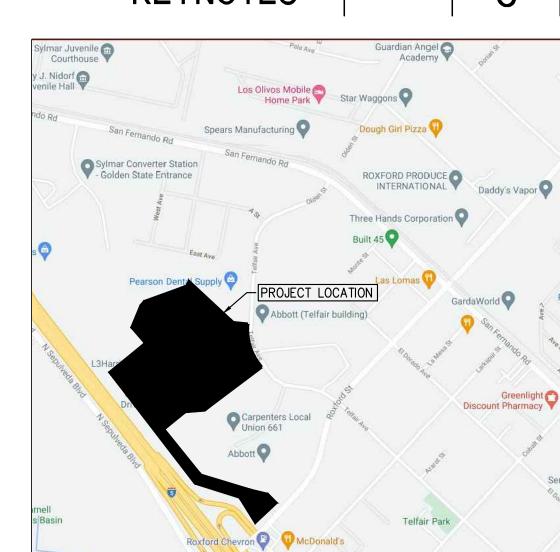

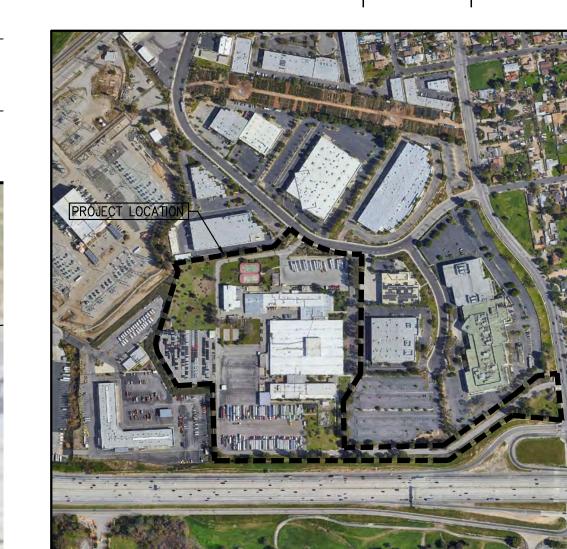

**AERIAL MAP** 

ENLARGED SITE PLAN **BUILDING 2** 

ALL DRAWINGS AND WRITTEN MATERIAL APPEARING HEREIN CONSTITUTE THE ORIGINAL AND UNPUBLISHED WORK OF TH ARCHITECT AND THE SAME MAY NOT BE DUPLICATED, USED OR (c) GAA ARCHITECTS. ALL RIGHTS RESERVED.

ARCHITECTS

8811 Research Drive,

Irvine, CA 92618

T: 949 474 1775

F: 949 553 9133

Suite 200,

TREET BLDG


RD 9134


Ō ◀

AR,

XRP040.01 7/28/21

**A**1.3 FILE NAME: XPR040.01\_A1 <sup>7</sup>

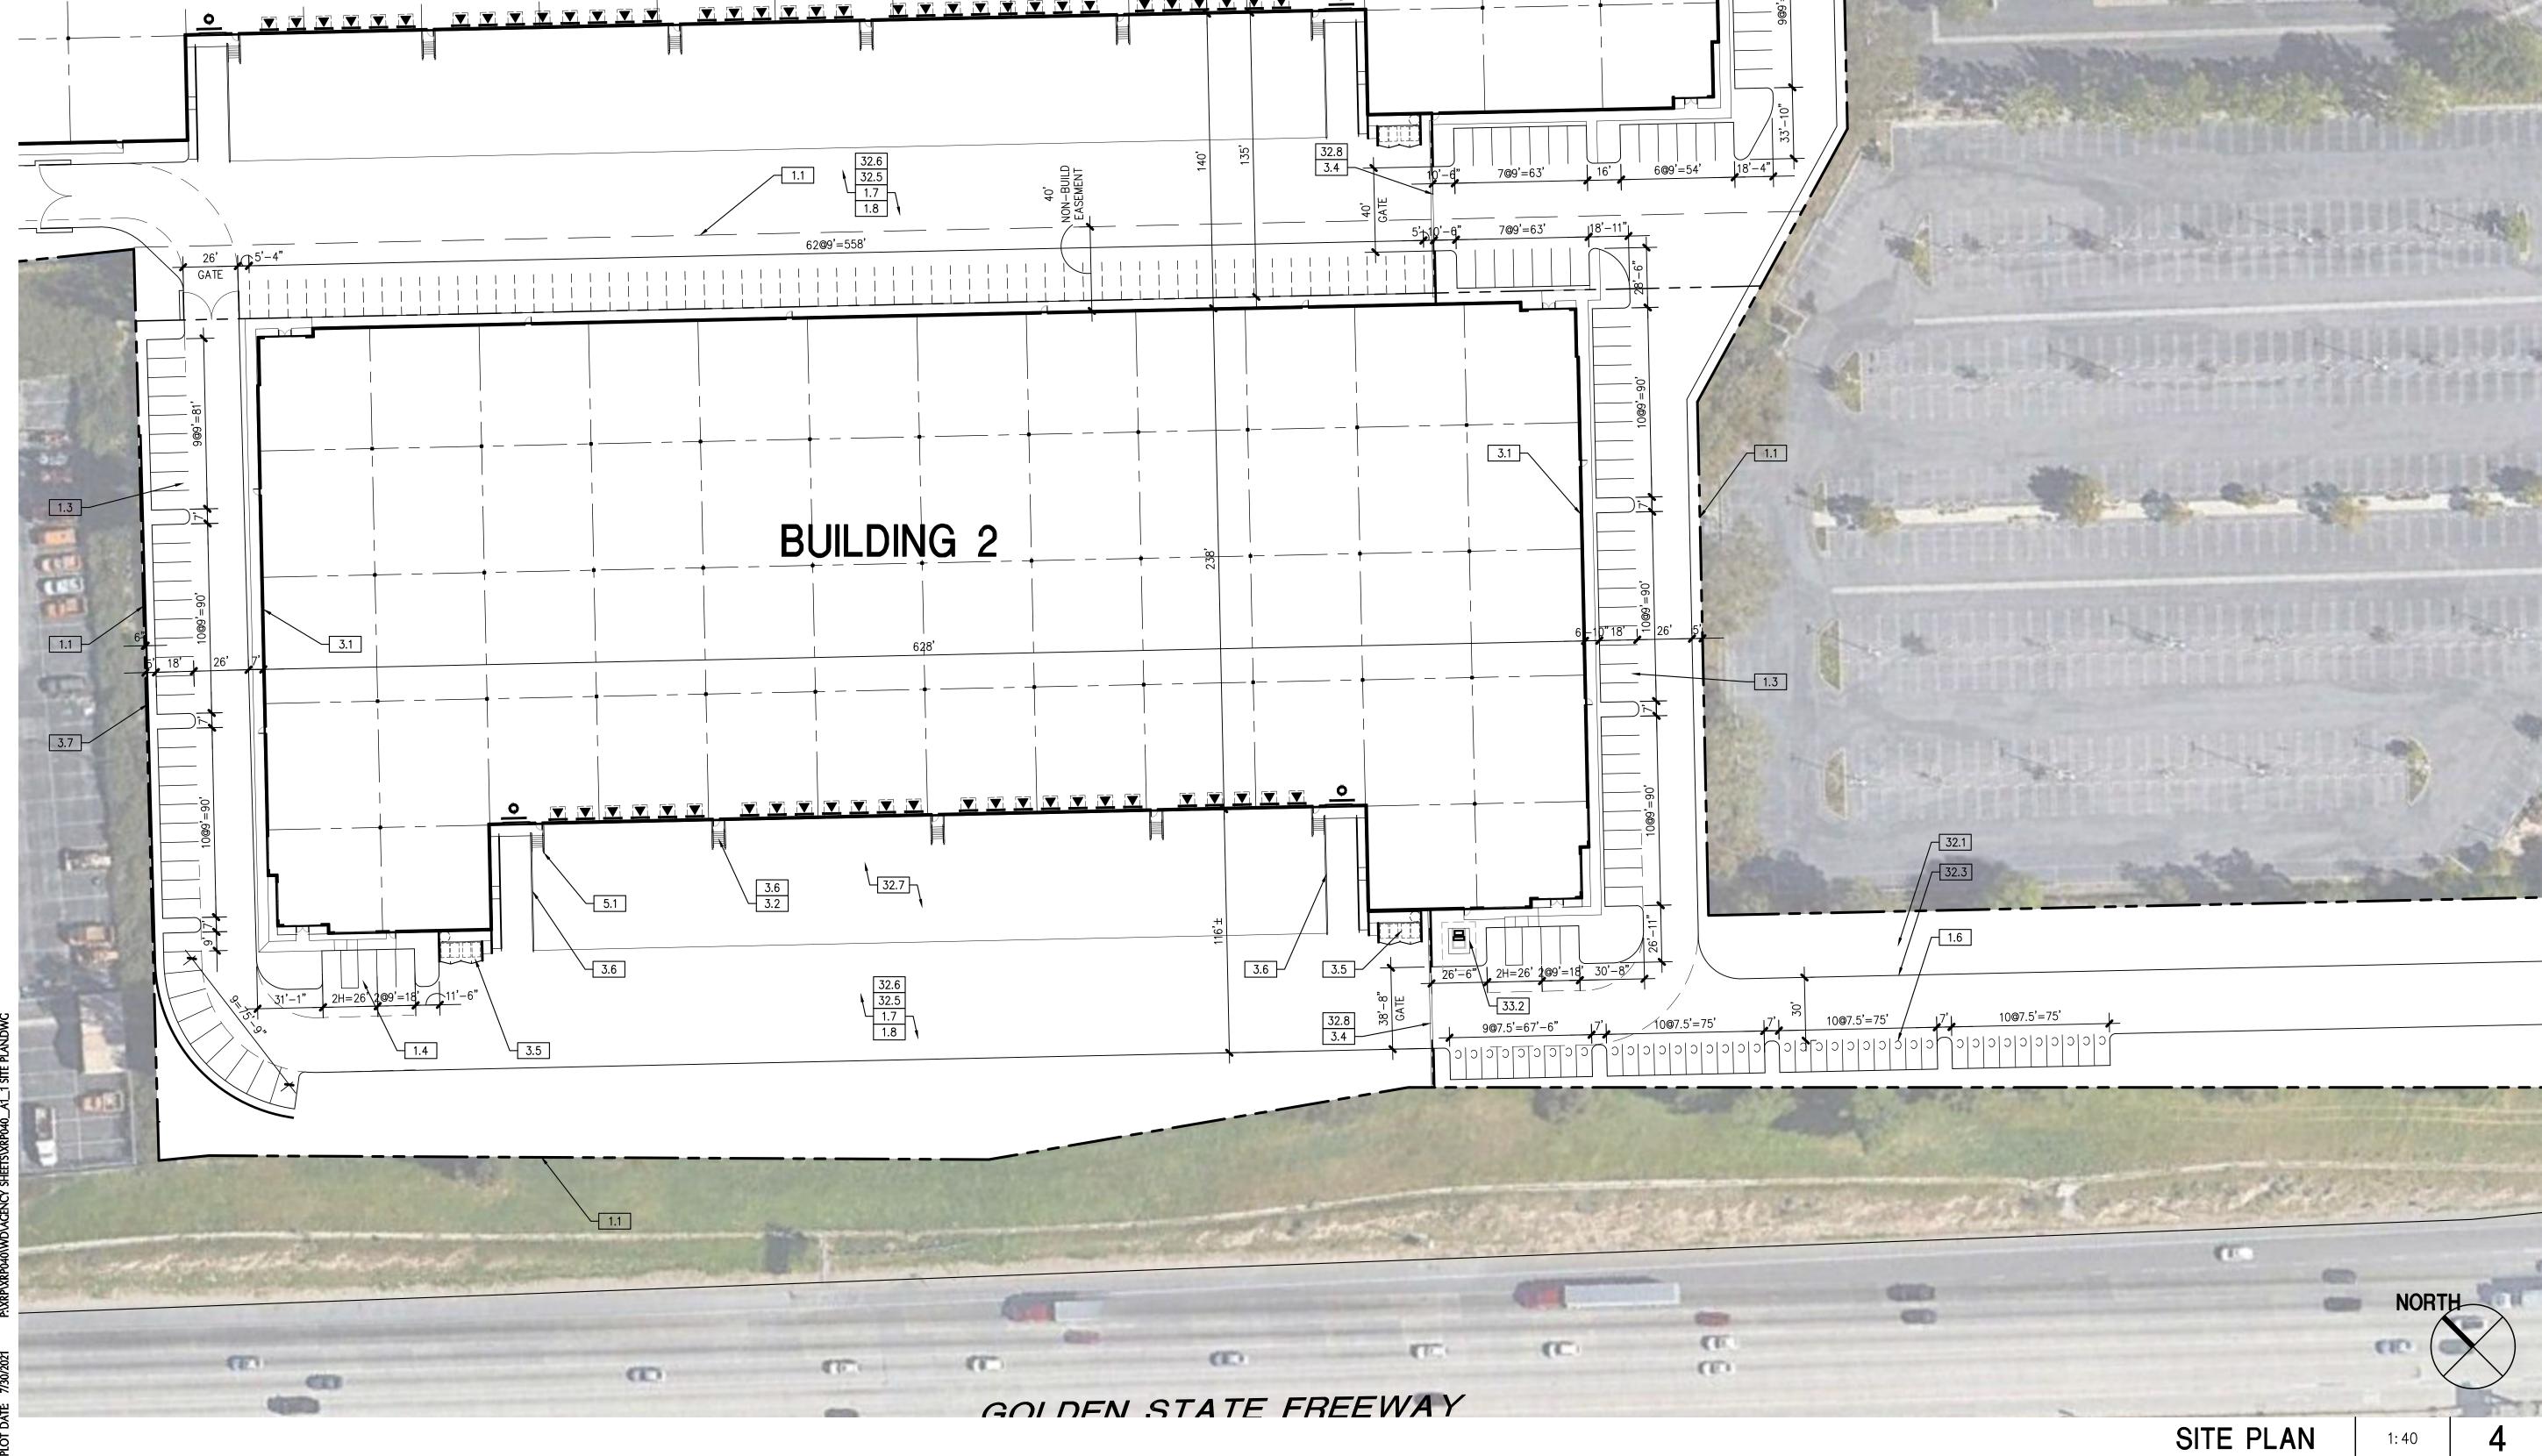

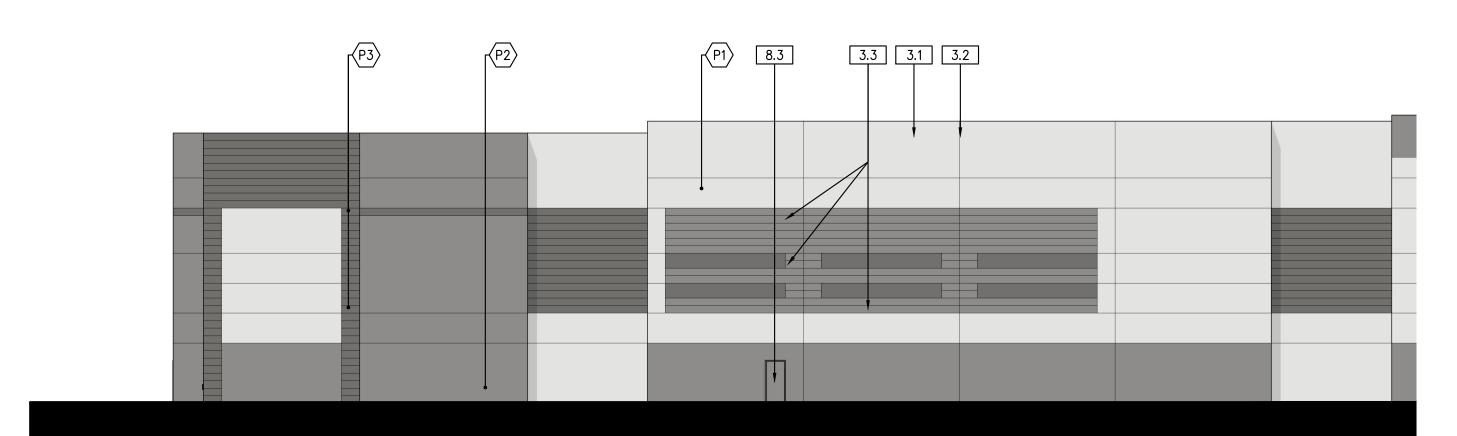

8.1

WEST ELEVATION

1/16"=1'

#### **KEYNOTES**

- 1.1 INTERIOR CLEAR HEIGHT X' MEASURED FROM X 1.2 LINE OF ROOF BEYOND
- 3.0 CONCRETE
- 3.1 TILT-UP CONCRETE WALL PANEL (PAINTED, ALL EXTERIOR SURFACES) 3.2 PANEL JOINT 3.3 PANEL REVEAL. REVEAL COLOR TO MATCH ADJACENT FIELD COLOR. 3.4 CONCRETE STAIRS W/ HANDRAIL & 42" HIGH GUARDRAIL 3.5 TILT-UP CONCRETE SCREEN WALL PANEL (PAINTED ALL SIDES)
- 5.1 EXTERIOR METAL DOWNSPOUT WITH ROOF AND OVERFLOW SCUPPER. ROOF DRAIN TO MANIFOLD TO STORM DRAIN, PAINTED TO MATCH ADJACENT WALL.
  - 5.2 METAL CANOPY
- 8.1 EXTRUDED ALUMINUM AND GLASS STOREFRONT, DUAL GLAZE 8.2 ALUMINUM AND GLASS ENTRY DOOR - REFER TO DOOR SCHEDULE 8.3 HOLLOW METAL MAN DOOR, PAINTED 8.4 9'W x 10'H OVERHEAD SECTIONAL DOCK DOOR, PAINTED 8.5 12'W x 14'H OVERHEAD SECTIONAL GRADE DOOR, PAINTED
- 10.1 STREET ADDRESS SIZE AS REQUIRED BY GOVERNING AGENCY BUT NOT LESS THAN 12"
- 10.2 BUILDING/ TENANT SIGNAGE (N.I.C.) 11.0 EQUIPMENT
- 11.1 DOCK BUMPERS COORDINATE W/ MFR & STRUCTURAL DRAWINGS. SIZE AS NEEDED TO PREVENT TOP OF TRAILER FROM STRIKING BUILDING WALL.
- 22.0 PLUMBING 22.1 INTERNAL ROOF DRAIN W/ OVERFLOW DRAIN TYP. AT ENTRY AND STREETSIDE ELEVATION (NOT SHOWN)

#### **GENERAL NOTES**


- . MECHANICAL ROOF EQUIPMENT TO BE SCREENED FROM VIEW. 2. ALL PAINT COLOR CHANGES TO OCCUR AT INSIDE CORNERS AND REVEAL LINES UNLESS NOTED OTHERWISE. REVEAL COLOR TO MATCH THE ADJACENT FIELD COLOR. 3. PROVIDE 8'-0" WIDE COLOR SAMPLE ON BUILDING, FULL HEIGHT FROM BASE TO
- PARAPET FOR APPROVAL BY ARCHITECT AND OWNER PRIOR TO PAINTING. 4. ALL PAINT, STAIN, SANDBLAST, ETC. FINISHES AND JOINTS/REVEALS SHOWN IN ELEVATION VIEW SHALL RETURN TO THE NEAREST INSIDE CORNER OR INTO WINDOW
- 5. ALL WALL PAINT FINISHES ARE TO BE FLAT, METAL PAINT TO BE SEMI-GLOSS UNLESS NOTED OTHERWISE.
- 6. BACK SIDE OF PARAPETS TO HAVE SMOOTH FINISH AND BE PAINTED WITH
- ELASTOMERIC PAINT. 7. T.O.P. = TOP OF PARAPET ELEVATION
- 8. F.F. = FINISH FLOOR ELEVATION 9. MEZZ. = MEZZANINE FLOOR ELEVATION
- 10. STOREFRONT CONSTRUCTION: GLASS, METAL ATTACHMENTS, AND LINTELS SHALL BE DESIGNED TO RESIST 90 MPH EXPOSURE "C" WINDS. CONTRACTOR SHALL SUBMIT SHOP DRAWINGS PRIOR TO INSTALLATION.

#### COLOR SCHEDULE / MATERIALS


- MEDIUM PERFORMANCE COLOR: BLUE ALUMINUM FINISH: CLEAR ANODIZED
- FINISH: CLEAR ANODIZED
  ALUMINUM
  FINISH: CLEAR ANODIZED
  DUNN EDWARDS "PORPOISE" DE6373 OR SIMILAR
  MAIN BUILDING COLOR LIGHT
  DUNN EDWARDS "LOOKING GLASS" DE6376 OR SIMILAR
  BUILDING BASE COLOR MEDIUM
  DUNN EDWARDS "BOAT ANCHOR" DE6377 OR SIMILAR
  DARK BAND COLOR DARK

DOORS TO MATCH ADJACENT BUILDING COLOR

KEYNOTES 2

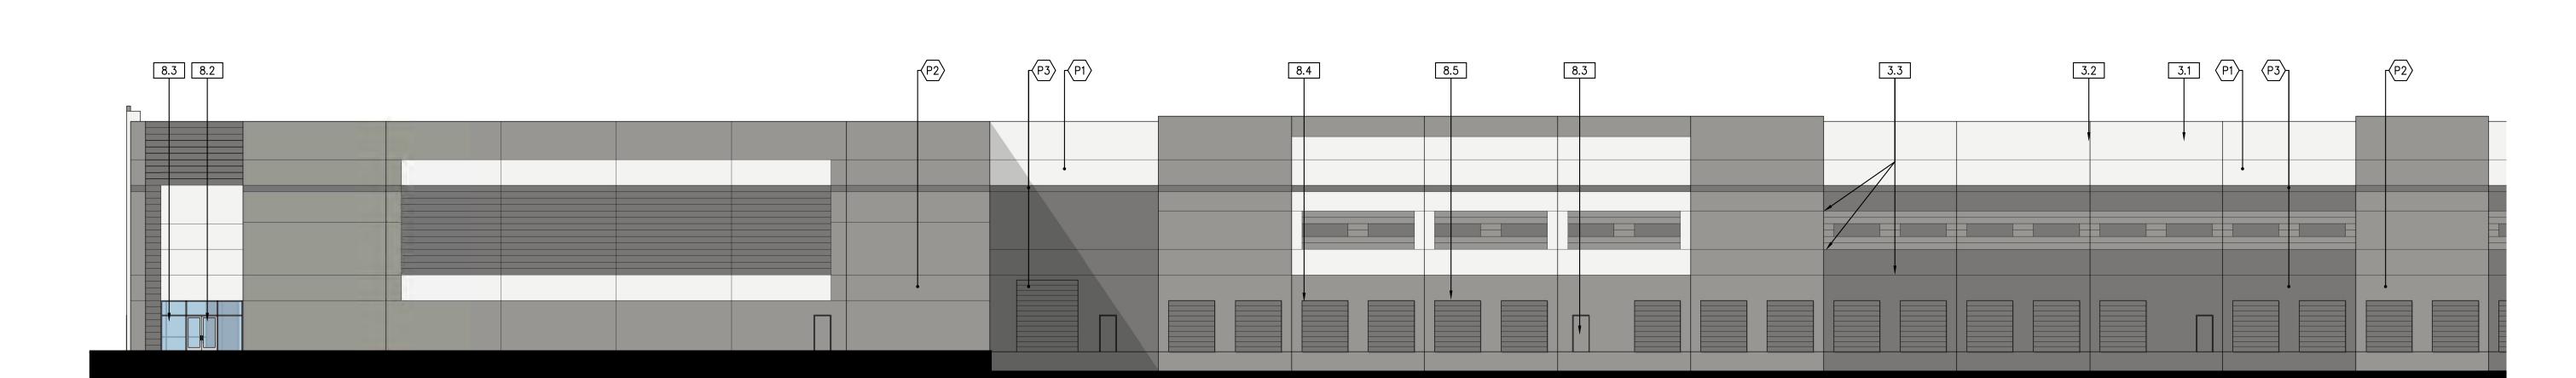

P2

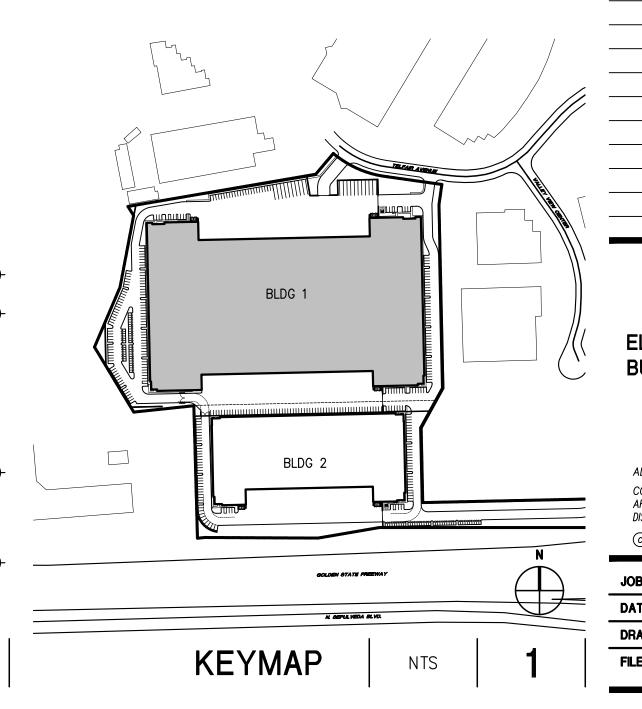

NO. DESCRIPTION A PROGRESS SET 07/30/21

ARCHITECTS

8811 Research Drive,

Irvine, CA 92618

T: 949 474 1775

F: 949 553 9133

Suite 200,

TREET BLDG

ROXFORD ST. AR, CA 91342

ROXI INDU 15825 F SYLMA


DEVELOPED ROXFORD X(

**ELEVATIONS BUILDING 1** 

ALL DRAWINGS AND WRITTEN MATERIAL APPEARING HEREIN CONSTITUTE THE ORIGINAL AND UNPUBLISHED WORK OF THE ARCHITECT AND THE SAME MAY NOT BE DUPLICATED, USED OR DISCLOSED WITHOUT THE EXPRESS WRITTEN CONSENT OF THE ARCHITECT. © GAA ARCHITECTS. ALL RIGHTS RESERVED.

XRP040.01 7/28/21 A4.1 DRAWN: GAA FILE NAME: XRP040.01\_A4.1

P2 8.5 3.2 NORTH ELEVATION

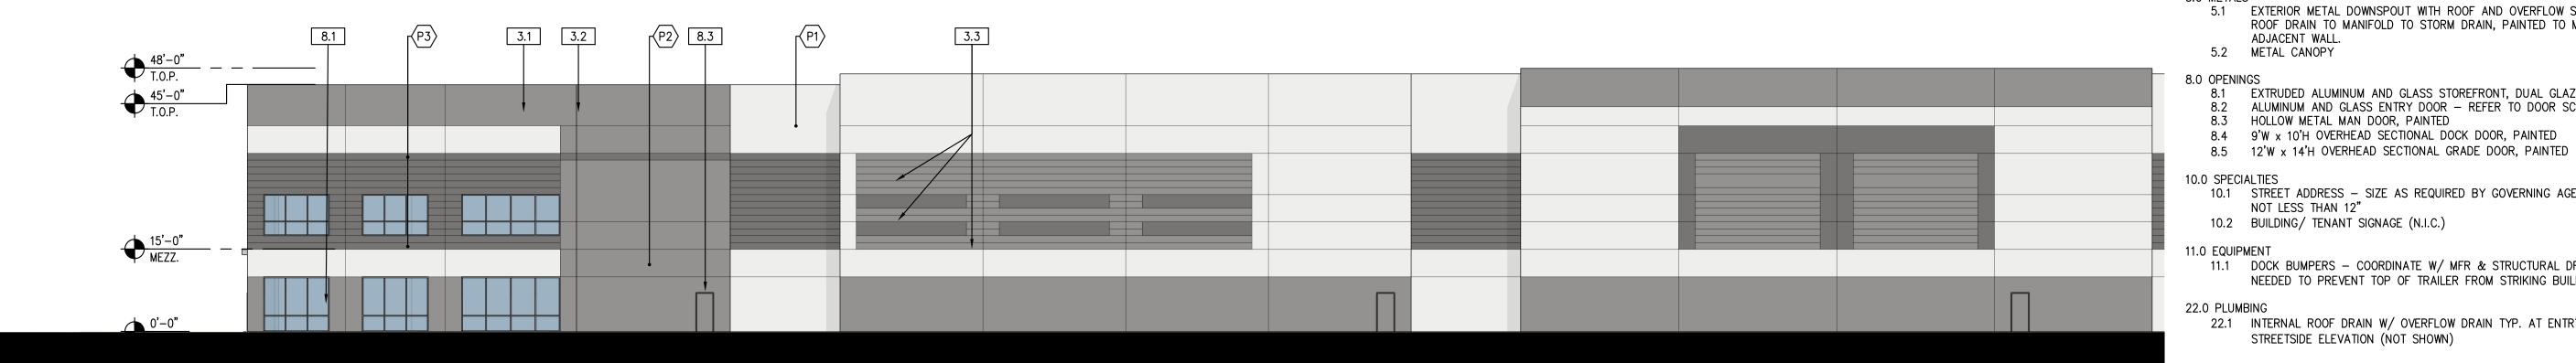

# 3.3 8.3 3.1 3.2

**KEYNOTES** 

1.1 INTERIOR CLEAR HEIGHT X' MEASURED FROM X 1.2 LINE OF ROOF BEYOND

3.0 CONCRETE

3.1 TILT-UP CONCRETE WALL PANEL (PAINTED, ALL EXTERIOR SURFACES) 3.2 PANEL JOINT 3.3 PANEL REVEAL. REVEAL COLOR TO MATCH ADJACENT FIELD COLOR. 3.4 CONCRETE STAIRS W/ HANDRAIL & 42" HIGH GUARDRAIL 3.5 TILT-UP CONCRETE SCREEN WALL PANEL (PAINTED ALL SIDES)

5.1 EXTERIOR METAL DOWNSPOUT WITH ROOF AND OVERFLOW SCUPPER. ROOF DRAIN TO MANIFOLD TO STORM DRAIN, PAINTED TO MATCH ADJACENT WALL.

5.2 METAL CANOPY 8.1 EXTRUDED ALUMINUM AND GLASS STOREFRONT, DUAL GLAZE 8.2 ALUMINUM AND GLASS ENTRY DOOR - REFER TO DOOR SCHEDULE 8.3 HOLLOW METAL MAN DOOR, PAINTED 8.4 9'W x 10'H OVERHEAD SECTIONAL DOCK DOOR, PAINTED

10.1 STREET ADDRESS — SIZE AS REQUIRED BY GOVERNING AGENCY BUT NOT LESS THAN 12" 10.2 BUILDING/ TENANT SIGNAGE (N.I.C.)

11.0 EQUIPMENT 11.1 DOCK BUMPERS - COORDINATE W/ MFR & STRUCTURAL DRAWINGS. SIZE AS NEEDED TO PREVENT TOP OF TRAILER FROM STRIKING BUILDING WALL.

22.1 INTERNAL ROOF DRAIN W/ OVERFLOW DRAIN TYP. AT ENTRY AND STREETSIDE ELEVATION (NOT SHOWN)

#### **GENERAL NOTES**

1. MECHANICAL ROOF EQUIPMENT TO BE SCREENED FROM VIEW. 2. ALL PAINT COLOR CHANGES TO OCCUR AT INSIDE CORNERS AND REVEAL LINES UNLESS NOTED OTHERWISE. REVEAL COLOR TO MATCH THE ADJACENT FIELD COLOR. 3. PROVIDE 8'-0" WIDE COLOR SAMPLE ON BUILDING, FULL HEIGHT FROM BASE TO

PARAPET FOR APPROVAL BY ARCHITECT AND OWNER PRIOR TO PAINTING. 4. ALL PAINT, STAIN, SANDBLAST, ETC. FINISHES AND JOINTS/REVEALS SHOWN IN ELEVATION VIEW SHALL RETURN TO THE NEAREST INSIDE CORNER OR INTO WINDOW

5. ALL WALL PAINT FINISHES ARE TO BE FLAT, METAL PAINT TO BE SEMI-GLOSS UNLESS NOTED OTHERWISE.

6. BACK SIDE OF PARAPETS TO HAVE SMOOTH FINISH AND BE PAINTED WITH ELASTOMERIC PAINT.

7. T.O.P. = TOP OF PARAPET ELEVATION 8. F.F. = FINISH FLOOR ELEVATION 9. MEZZ. = MEZZANINE FLOOR ELEVATION

10. STOREFRONT CONSTRUCTION: GLASS, METAL ATTACHMENTS, AND LINTELS SHALL BE DESIGNED TO RESIST 90 MPH EXPOSURE "C" WINDS. CONTRACTOR SHALL SUBMIT SHOP DRAWINGS PRIOR TO INSTALLATION.

#### COLOR SCHEDULE / MATERIALS

MEDIUM PERFORMANCE COLOR: BLUE ALUMINUM FINISH: CLEAR ANODIZED

ALUMINUM

ALUMINUM
FINISH: CLEAR ANODIZED
DUNN EDWARDS "PORPOISE" DE6373 OR SIMILAR
MAIN BUILDING COLOR — LIGHT
DUNN EDWARDS "LOOKING GLASS" DE6376 OR SIMILAR
BUILDING BASE COLOR — MEDIUM
DUNN EDWARDS "BOAT ANCHOR" DE6377 OR SIMILAR
DARK BAND COLOR — DARK

KEYNOTES

DOORS TO MATCH ADJACENT BUILDING COLOR

ROXFORD ST. AR, CA 91342 ROXI INDU 15825 F SYLMA

DEVELOPED FOR ROXFORD XC I

TREET BLDG


ARCHITECTS

8811 Research Drive,

Suite 200, Irvine, CA 92618

T: 949 474 1775 F: 949 553 9133

8.4 8.1 

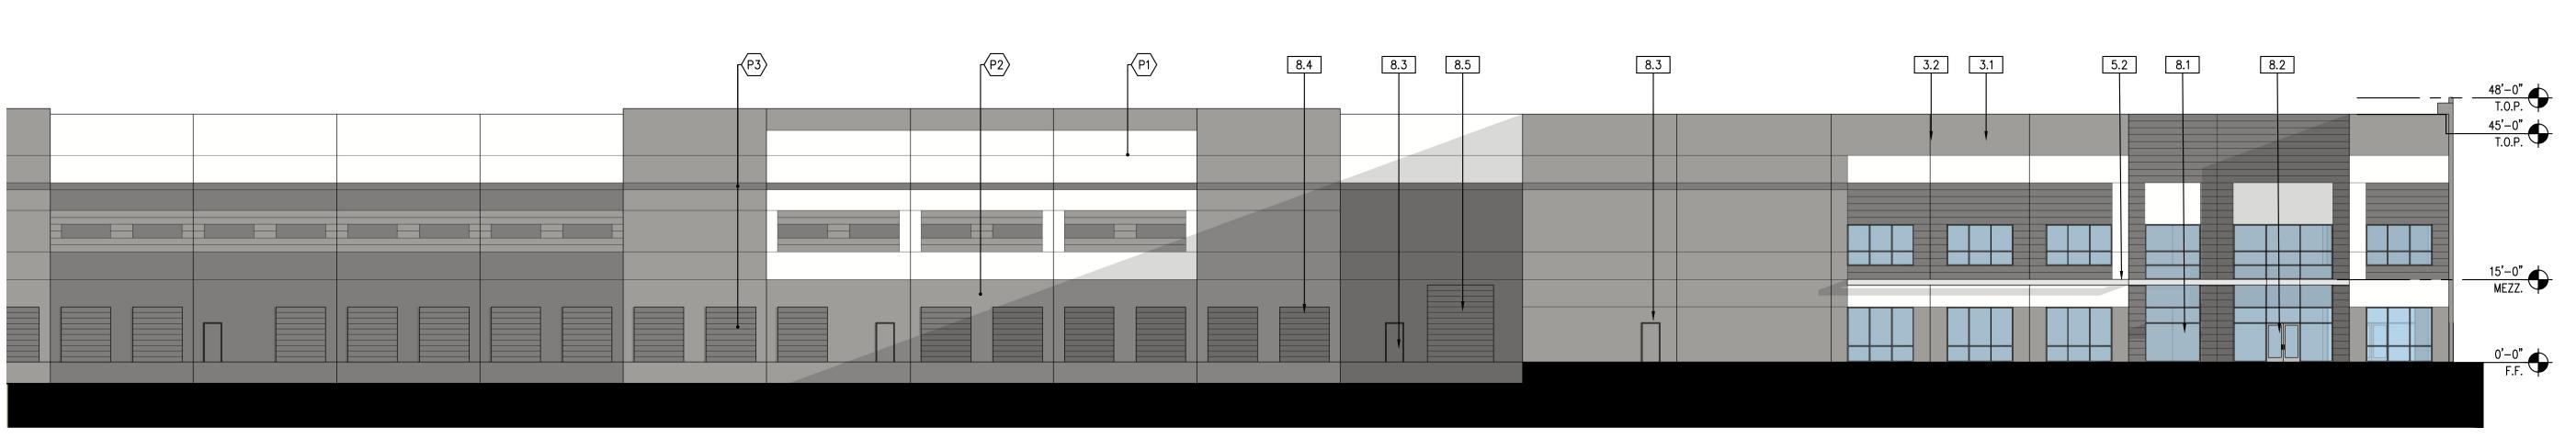

BLDG 1 BLDG 2

A PROGRESS SET 07/30/21 **ELEVATIONS BUILDING 1** 


NO. DESCRIPTION

ALL DRAWINGS AND WRITTEN MATERIAL APPEARING HEREIN CONSTITUTE THE ORIGINAL AND UNPUBLISHED WORK OF THE ARCHITECT AND THE SAME MAY NOT BE DUPLICATED, USED OR DISCLOSED WITHOUT THE EXPRESS WRITTEN CONSENT OF THE ARCHITECT. © GAA ARCHITECTS. ALL RIGHTS RESERVED.

XRP040.01 7/28/21 A4.1A DRAWN: FILE NAME: XRP040.01\_A4.1A

SOUTH ELEVATION 1/16"=1' 3

EAST ELEVATION

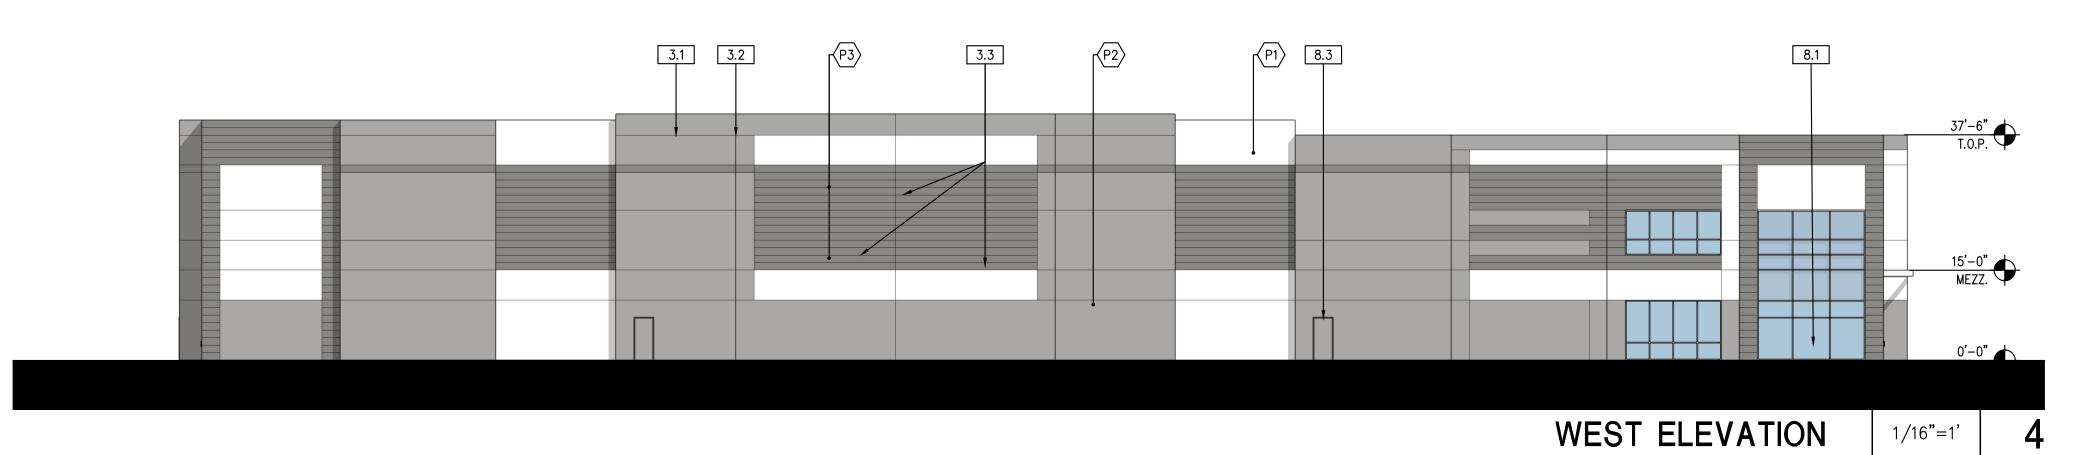

## **KEYNOTES**

1.0 GENERAL
1.1 INTERIOR CLEAR HEIGHT X' MEASURED FROM X 1.2 LINE OF ROOF BEYOND

3.0 CONCRETE

3.1 TILT-UP CONCRETE WALL PANEL (PAINTED, ALL EXTERIOR SURFACES) 3.2 PANEL JOINT 3.3 PANEL REVEAL REVEAL COLOR TO MATCH ADJACENT FIELD COLOR. 3.4 CONCRETE STAIRS W/ HANDRAIL & 42" HIGH GUARDRAIL

3.5 TILT-UP CONCRETE SCREEN WALL PANEL (PAINTED ALL SIDES) 5.1 EXTERIOR METAL DOWNSPOUT WITH ROOF AND OVERFLOW SCUPPER.

ROOF DRAIN TO MANIFOLD TO STORM DRAIN, PAINTED TO MATCH ADJACENT WALL. 5.2 METAL CANOPY

8.1 EXTRUDED ALUMINUM AND GLASS STOREFRONT, DUAL GLAZE 8.2 ALUMINUM AND GLASS ENTRY DOOR - REFER TO DOOR SCHEDULE 8.3 HOLLOW METAL MAN DOOR, PAINTED

8.4 9'W x 10'H OVERHEAD SECTIONAL DOCK DOOR, PAINTED 8.5 12'W x 14'H OVERHEAD SECTIONAL GRADE DOOR, PAINTED

10.1 STREET ADDRESS - SIZE AS REQUIRED BY GOVERNING AGENCY BUT

NOT LESS THAN 12" 10.2 BUILDING/ TENANT SIGNAGE (N.I.C.)

11.0 EQUIPMENT 11.1 DOCK BUMPERS - COORDINATE W/ MFR & STRUCTURAL DRAWINGS. SIZE AS NEEDED TO PREVENT TOP OF TRAILER FROM STRIKING BUILDING WALL.

22.0 PLUMBING 22.1 INTERNAL ROOF DRAIN W/ OVERFLOW DRAIN TYP. AT ENTRY AND STREETSIDE ELEVATION (NOT SHOWN)

#### **GENERAL NOTES**

1. MECHANICAL ROOF EQUIPMENT TO BE SCREENED FROM VIEW. 2. ALL PAINT COLOR CHANGES TO OCCUR AT INSIDE CORNERS AND REVEAL LINES UNLESS NOTED OTHERWISE. REVEAL COLOR TO MATCH THE ADJACENT FIELD COLOR. 3. PROVIDE 8'-0" WIDE COLOR SAMPLE ON BUILDING, FULL HEIGHT FROM BASE TO PARAPET FOR APPROVAL BY ARCHITECT AND OWNER PRIOR TO PAINTING.

4. ALL PAINT, STAIN, SANDBLAST, ETC. FINISHES AND JOINTS/REVEALS SHOWN IN ELEVATION VIEW SHALL RETURN TO THE NEAREST INSIDE CORNER OR INTO WINDOW 5. ALL WALL PAINT FINISHES ARE TO BE FLAT, METAL PAINT TO BE SEMI-GLOSS

UNLESS NOTED OTHERWISE. 6. BACK SIDE OF PARAPETS TO HAVE SMOOTH FINISH AND BE PAINTED WITH ELASTOMERIC PAINT.

7. T.O.P. = TOP OF PARAPET ELEVATION 8. F.F. = FINISH FLOOR ELEVATION

9. MEZZ. = MEZZANINE FLOOR ELEVATION 10. STOREFRONT CONSTRUCTION: GLASS, METAL ATTACHMENTS, AND LINTELS SHALL BE DESIGNED TO RESIST 90 MPH EXPOSURE "C" WINDS. CONTRACTOR SHALL SUBMIT SHOP DRAWINGS PRIOR TO INSTALLATION.

#### COLOR SCHEDULE / MATERIALS


MEDIUM PERFORMANCE COLOR: BLUE ALUMINUM


FINISH: CLEAR ANODIZED


FINISH: CLEAR ANODIZED
ALUMINUM
FINISH: CLEAR ANODIZED
DUNN EDWARDS "PORPOISE" DE6373 OR SIMILAR
MAIN BUILDING COLOR — LIGHT
DUNN EDWARDS "LOOKING GLASS" DE6376 OR SIMILAR
BUILDING BASE COLOR — MEDIUM
DUNN EDWARDS "BOAT ANCHOR" DE6377 OR SIMILAR
DARK BAND COLOR — DARK

DOORS TO MATCH ADJACENT BUILDING COLOR

KEYNOTES -

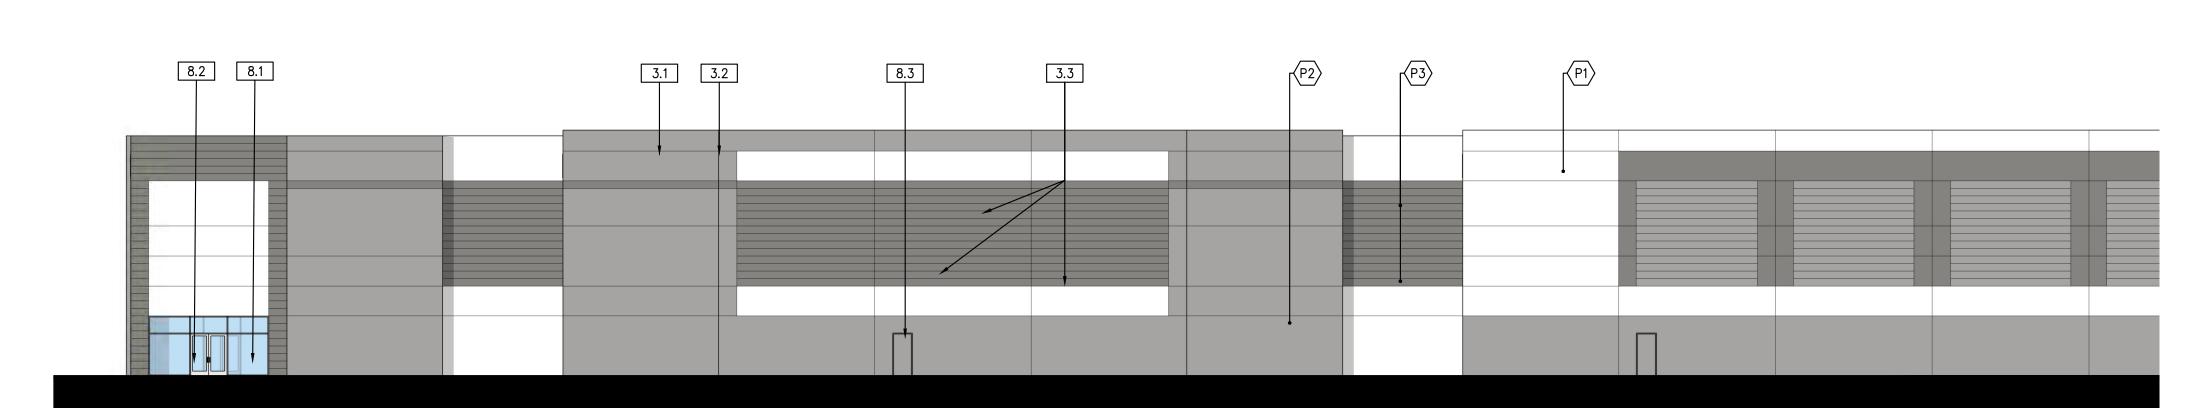

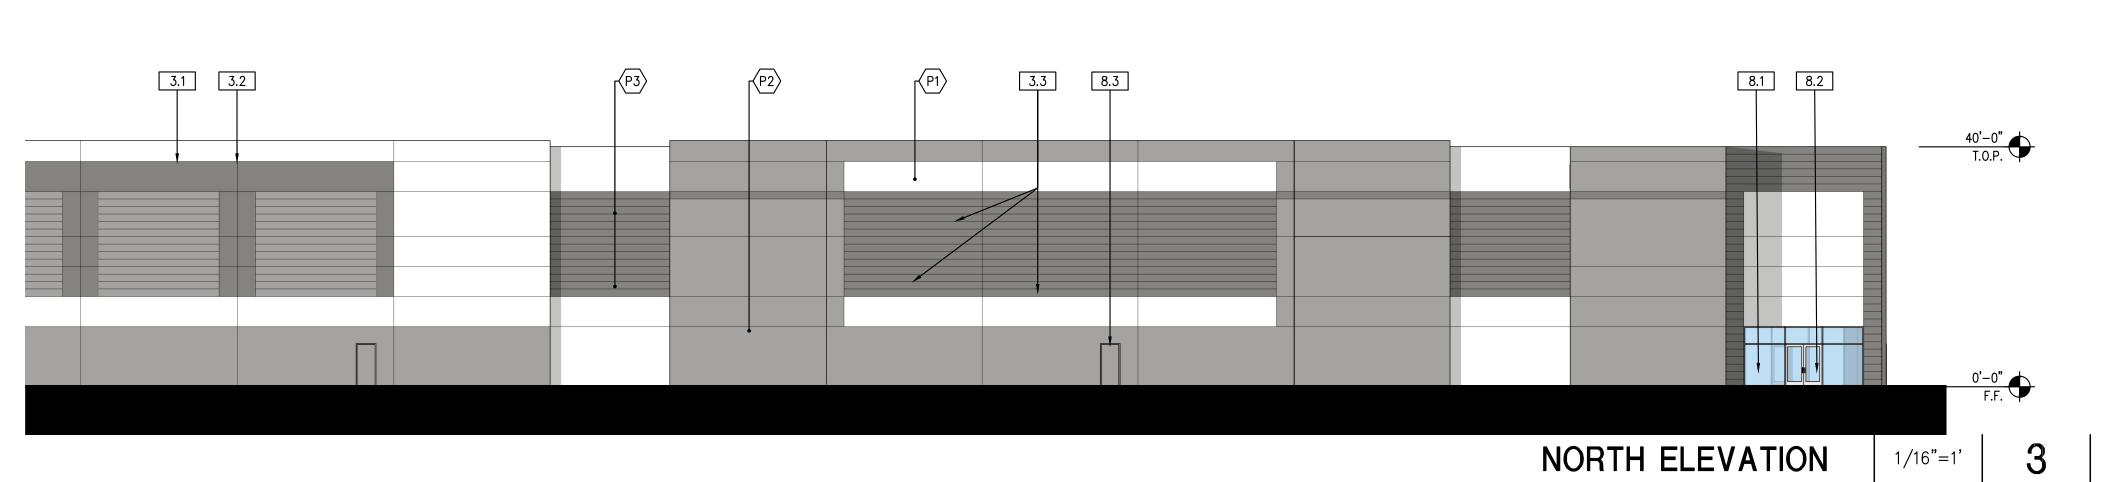

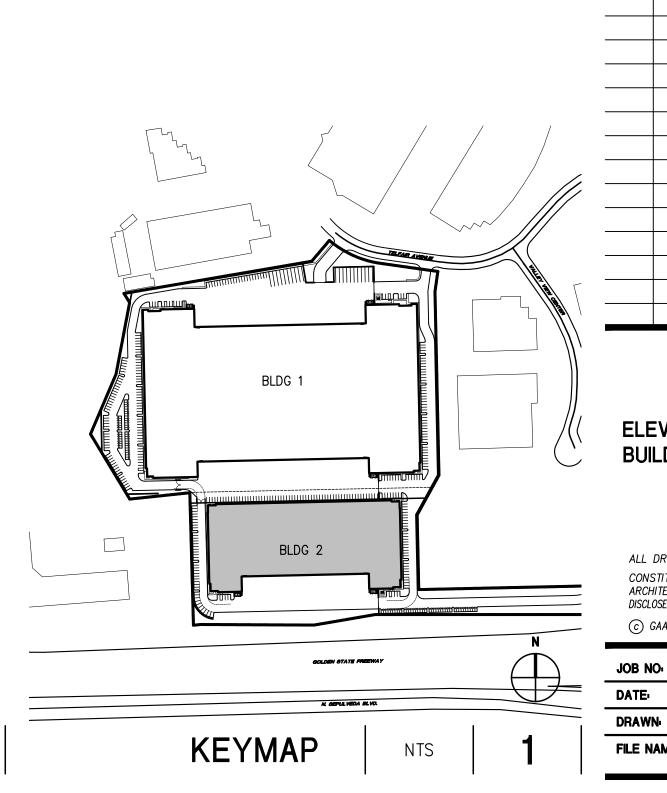

**ELEVATIONS BUILDING 2** ALL DRAWINGS AND WRITTEN MATERIAL APPEARING HEREIN

ARCHITECTS

8811 Research Drive,

Irvine, CA 92618

T: 949 474 1775 F: 949 553 9133

Suite 200,

TREET BLDG

ROXFORD ST. AR, CA 91342

ROXI INDU 15825 F SYLMA

NO. DESCRIPTION


A PROGRESS SET

DEVELOPED FC ROXFORD XC 1

07/30/21

CONSTITUTE THE ORIGINAL AND UNPUBLISHED WORK OF THE ARCHITECT AND THE SAME MAY NOT BE DUPLICATED, USED OR DISCLOSED WITHOUT THE EXPRESS WRITTEN CONSENT OF THE ARCHITECT. (c) GAA ARCHITECTS. ALL RIGHTS RESERVED. XRP040.01

7/28/21 A4.2 FILE NAME: XRP040.01\_A4.2

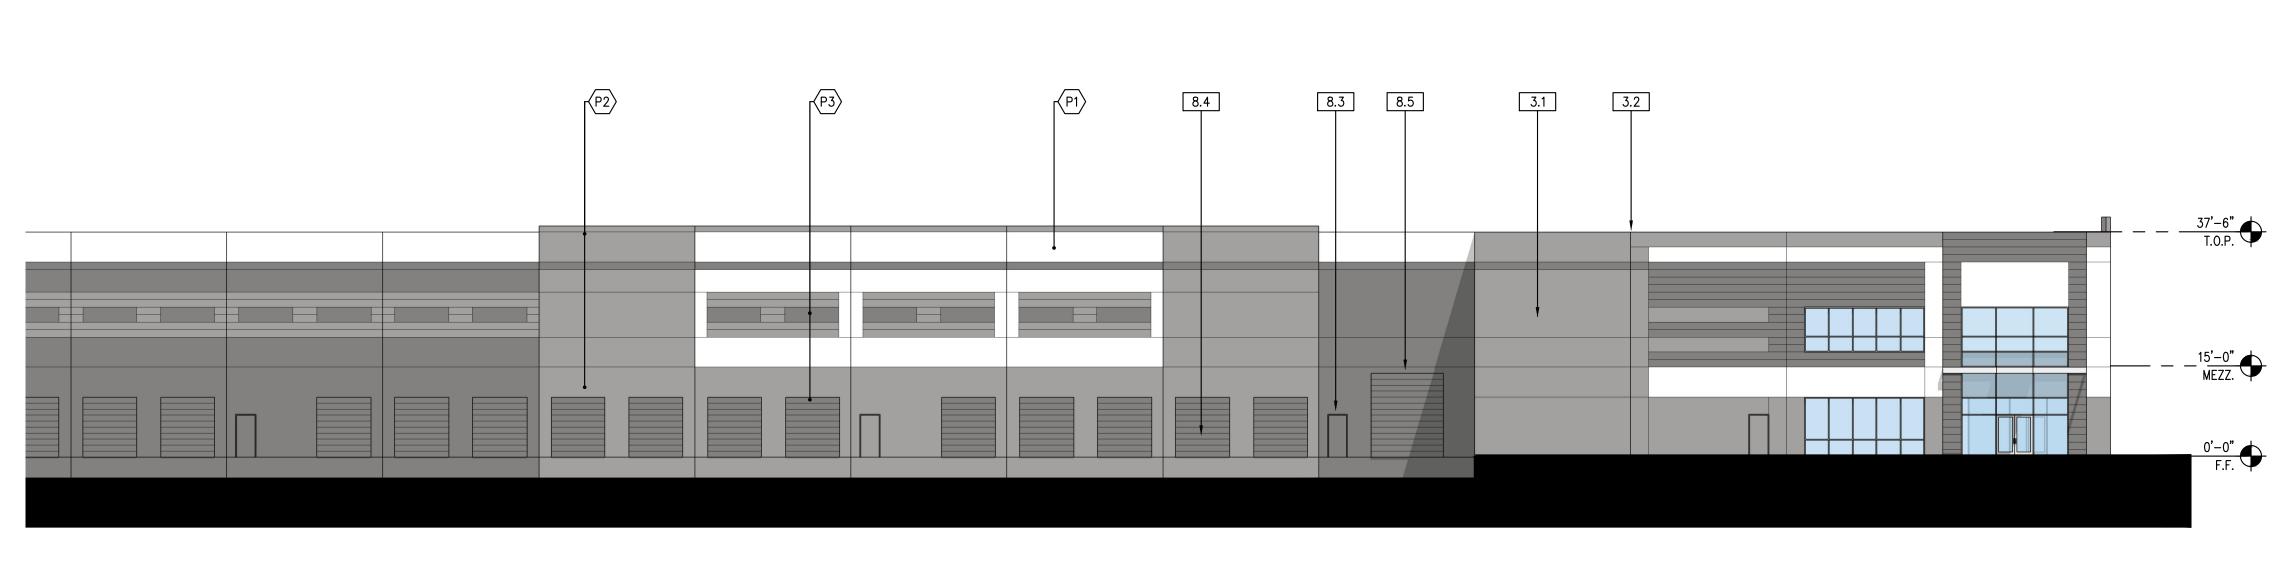

SOUTH ELEVATION 1/16"=1' 3

**KEYNOTES** 

1.1 INTERIOR CLEAR HEIGHT X' MEASURED FROM X 1.2 LINE OF ROOF BEYOND

3.0 CONCRETE

3.1 TILT-UP CONCRETE WALL PANEL (PAINTED, ALL EXTERIOR SURFACES) 3.2 PANEL JOINT 3.3 PANEL REVEAL. REVEAL COLOR TO MATCH ADJACENT FIELD COLOR. 3.4 CONCRETE STAIRS W/ HANDRAIL & 42" HIGH GUARDRAIL 3.5 TILT-UP CONCRETE SCREEN WALL PANEL (PAINTED ALL SIDES)

5.0 METALS 5.1 EXTERIOR METAL DOWNSPOUT WITH ROOF AND OVERFLOW SCUPPER. ROOF DRAIN TO MANIFOLD TO STORM DRAIN, PAINTED TO MATCH ADJACENT WALL.

5.2 METAL CANOPY

8.1 EXTRUDED ALUMINUM AND GLASS STOREFRONT, DUAL GLAZE 8.2 ALUMINUM AND GLASS ENTRY DOOR - REFER TO DOOR SCHEDULE 8.3 HOLLOW METAL MAN DOOR, PAINTED 8.4 9'W x 10'H OVERHEAD SECTIONAL DOCK DOOR, PAINTED 8.5 12'W x 14'H OVERHEAD SECTIONAL GRADE DOOR, PAINTED

10.0 SPECIALTIES 10.1 STREET ADDRESS - SIZE AS REQUIRED BY GOVERNING AGENCY BUT NOT LESS THAN 12" 10.2 BUILDING/ TENANT SIGNAGE (N.I.C.)

11.0 EQUIPMENT 11.1 DOCK BUMPERS - COORDINATE W/ MFR & STRUCTURAL DRAWINGS. SIZE AS NEEDED TO PREVENT TOP OF TRAILER FROM STRIKING BUILDING WALL.

22.0 PLUMBING 22.1 INTERNAL ROOF DRAIN W/ OVERFLOW DRAIN TYP. AT ENTRY AND STREETSIDE ELEVATION (NOT SHOWN)

#### **GENERAL NOTES**

1. MECHANICAL ROOF EQUIPMENT TO BE SCREENED FROM VIEW. 2. ALL PAINT COLOR CHANGES TO OCCUR AT INSIDE CORNERS AND REVEAL LINES UNLESS NOTED OTHERWISE. REVEAL COLOR TO MATCH THE ADJACENT FIELD COLOR. 3. PROVIDE 8'-0" WIDE COLOR SAMPLE ON BUILDING, FULL HEIGHT FROM BASE TO

PARAPET FOR APPROVAL BY ARCHITECT AND OWNER PRIOR TO PAINTING. 4. ALL PAINT, STAIN, SANDBLAST, ETC. FINISHES AND JOINTS/REVEALS SHOWN IN ELEVATION VIEW SHALL RETURN TO THE NEAREST INSIDE CORNER OR INTO WINDOW

5. ALL WALL PAINT FINISHES ARE TO BE FLAT, METAL PAINT TO BE SEMI-GLOSS UNLESS NOTED OTHERWISE. 6. BACK SIDE OF PARAPETS TO HAVE SMOOTH FINISH AND BE PAINTED WITH

ELASTOMERIC PAINT. 7. T.O.P. = TOP OF PARAPET ELEVATION

SHOP DRAWINGS PRIOR TO INSTALLATION.

8. F.F. = FINISH FLOOR ELEVATION 9. MEZZ. = MEZZANINE FLOOR ELEVATION 10. STOREFRONT CONSTRUCTION: GLASS, METAL ATTACHMENTS, AND LINTELS SHALL BE

DESIGNED TO RESIST 90 MPH EXPOSURE "C" WINDS. CONTRACTOR SHALL SUBMIT

#### COLOR SCHEDULE / MATERIALS

G1 GLAZING MEDIUM PERFORMANCE COLOR: BLUE M1 CANOPY ALUMINUM FINISH: CLEAR ANODIZED

ALUMINUM

ALUMINUM
FINISH: CLEAR ANODIZED

DUNN EDWARDS "PORPOISE" DE6373 OR SIMILAR
MAIN BUILDING COLOR — LIGHT


DUNN EDWARDS "LOOKING GLASS" DE6376 OR SIMILAR
BUILDING BASE COLOR — MEDIUM

DUNN EDWARDS "BOAT ANCHOR" DE6377 OR SIMILAR

DARK BAND COLOR — DARK

DOORS TO MATCH ADJACENT BUILDING COLOR

KEYNOTES -

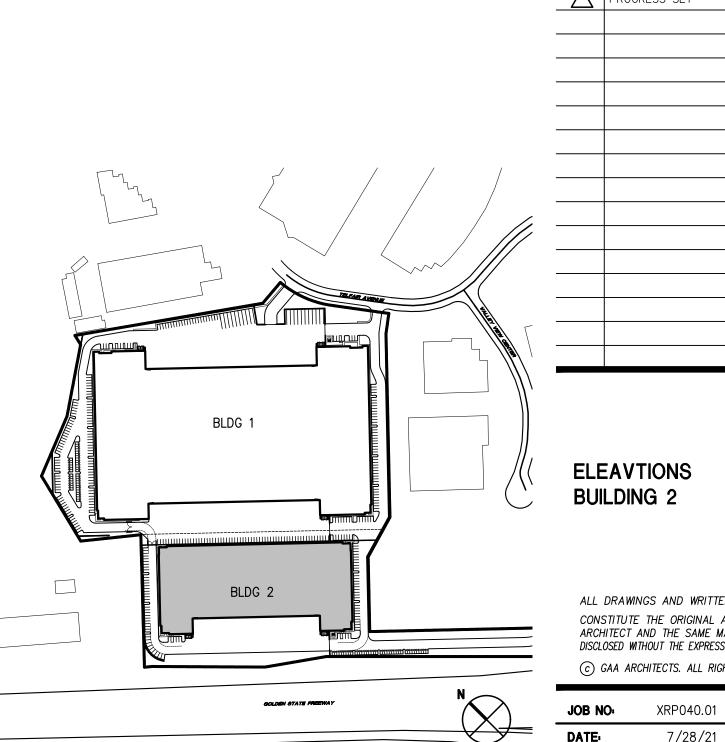

ARCHITECTS

8811 Research Drive, Suite 200, Irvine, CA 92618

T: 949 474 1775 F: 949 553 9133

TREET BLDG RD ST 91342 OA RO,

DEVELOPED ROXFORD X(

NO. DESCRIPTION A PROGRESS SET 07/30/21

ALL DRAWINGS AND WRITTEN MATERIAL APPEARING HEREIN CONSTITUTE THE ORIGINAL AND UNPUBLISHED WORK OF THE ARCHITECT AND THE SAME MAY NOT BE DUPLICATED, USED OR DISCLOSED WITHOUT THE EXPRESS WRITTEN CONSENT OF THE ARCHITECT. © GAA ARCHITECTS. ALL RIGHTS RESERVED.

7/28/21 A4.2A DRAWN: FILE NAME: XRP040.01\_A4.2A