

San Fernando

12188 - 12192 San Fernando Road Los Angeles, CA 91342

PZA Re-Submittal

Set Issue / Revisions:

11.21.2022 PZA Submittal 12.15.2022 1st Plan check Submittal 01.10.2023 PZA Re-submittal

Project Directory:

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Breen Design Group

Torrance, CA 90504

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Dry Utility:

E4 Utility Design Project Manager: Brandy McGuiree 1211 Puerta Del Sol #270 San Clemente, CA. 92673 949-582-2755 brandy@e4design.com

Savage Land Design Project Manager: Michael Savage 2651 E Chapman Ave #110 Fullerton, CA 92831 714.878.0335

michael@savagelanddesign.com

Project Summary:

General Requirements (See G0.04 - G0.16 For Additional Information)

Scope of Work:

- New Construction of a light gauge steel 5 story multi-family residential building, 100% privately funded
- New light gauge steel frame 5 story building (Type IIB) 121 Units ((121) 1 - Bedroom @ 385 SF, Avg.
- 100% Affordable AB 2345 Density Bonus project with requests for off-menu incentives and waivers.

Site Address :

12188 - 12192 San Fernando Road Los Angeles, CA 91342

Assessor Parcel Number (APN) :

2611-009-023, 2611-009-022

Legal Description:

Lots 21, 22, 23 and 24 of tract. No. 10143, in the City of Los Angeles, County of Los Angeles, State of California, as per Map recorded in book 145, pages 20 and 21 of maps, in the office of the county recorder of said county. Except thereform that portion of said lots 21, 22, 23 and 25 included within the deeds to State of California, recorded April 25, 1949 as instrument No. 2720 in book 29924 page 309 Official Records, and recorded May 17, 1949 as instrument No. 266 in book 30107 page 285 official records in the office of the county recorder of said county.

Base Zone:

C2-2D-CPIO; Corridor Subarea F ("Transit-Oriented Development")

Entitlements / Incentives :

100% Affordable AB 2345 Density Bonus project with requests for Off - Menu incentives and waivers:

- Density Bonus: Unlimited density and height (within ½ mile of major transit) PER AB2345
- Yard / Setback: Reduction of Side(s) Set Back to 5FT from 8FT (LAMC 12.22.25.(f).(1)) • Open Space: Up to 20% decrease from an open space requirement + 54.3% Reduction of Open Space
- Requirement. (LAMC 12.22.25.(f).(6))
- CPIO Glazing Requirement: 19% Reduction of CPIO Glazing Requirement (Refer G0.22) • Ground Floor Use: Waiver of the CPIO Ground - Floor Commercial Requirement for 75% of the Primary Frontage and Limitation of Dwelling Units on the Ground Level.
- Parking: Waiver of One (1) Paring Space for every 20 Dwelling Units or Guest Rooms

Lot Size : 18,829 SF

Density:

47 Dwelling Units (1/400 SF) Allowable Base Density: Allowable Density w/ AB 2345 Incentive: U/L Dwelling Units 121 DU (100% Affordable Housing) Proposed Density (Market Rate):

FAR (See Also G0.15):

Allowable FAR (Base FAR): Allowable FAR (Per 12.22.A.25): 4.05:1 (35% increased Density) Allowable Building Area FAR: 76,257 SF Proposed Building Area FAR: 54,590 SF

Building Area (See Also G0.05, G0.12 - 0.16) :

Gross Building Area: 59,559 SF 0 SF Parking Area:

Lot Coverage:

Building Footprint: See Plan L01 Landscape: See Plan L01

Height (See Also G0.05, A4.00 - 4.03):

Allowable Base Height Limit U/L for C2 60 FT (with Sylmar CPIO) Allowable Height: 52 FT 5 INCHES Proposed Height: Transitional Height Limit: Allowable Building Stories: Unlimited Proposed Building Stories: 5 Stories

Setbacks (See Also G0.05, A4.00 - 4.03):

Front Yard (San Fernando): (10' Dedication required / Sylmar CPIO req'd 10-6" front yard) Side Yard (North PL): 8'-0" 5'-0" Reduction of Side(s) Set Back to 5FT from 8FT for 100% Affordable AB 2345 Density Bonus project with requests for off-menu incentives and waivers Reduction of Side(s) Set Back to 5FT from 8FT for 100% Affordable AB Side Yard (South PL): 8'-0" 5'-0" 2345 Density Bonus project with requests for off-menu incentives and waivers 1'-6" 1'-6" Rear Yard (Truman Ave): Truman Ave is considered Front Yard (Refer to Sylmar CPIO reg'd)

Open Space (See Also G0.05 & G0.16):

Required Open Space: 9,680 SF Allowable Open Space w/ 20% decreased: 4,840 SF Minimum Common Open Space w/ AB 2345: Required Landscaping: 2,420 SF Required Trees:

Parking (See Also G0.05):

100% Affordable AB 2345 Density Bonus project with requests for off-menu incentives and waivers; including waiver of One (1) Parking Space for every 20 Dwelling Units or Guest Rooms.

Bicycle Parking (See Also G0.05):

Required Long-Term Parking: 103 Spaces; (103 Spaces Provided) 12 Spaces; (12 Spaces Provided) Required Short-Term Parking: Required Maintenance Area: 100 SF; (100 SF Provided)

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> Fernando **San** 12188 - 121



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PROJECT NO:	202203
DRAWN BY:	Author
CHECKED BY :	Checker
SCALE :	12" = 1'-0"

SHEET NO:

G0.00

A7.40 Typical Unit Kitchen Plans & Elevations

A7.60 Enlarged Bike Storage Plans & Details • •

A7.50 Unit Bathroom Plans & Elevations
A7.52 Bike -Enlarged Common Area Plan



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idex of Drawings



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01.10.2023	PZA Re-submittal	

PROJECT NO :	202203
DRAWN BY :	Author
CHECKED BY:	Checker
SCALE:	

SHEET NO:

G0.01

GND Ground GSM Galvanized Sheet Metal

GWB Gypsum Wall Board

RM

RO

RSR

Room Round

RV Roof Vent R/W Right of Way

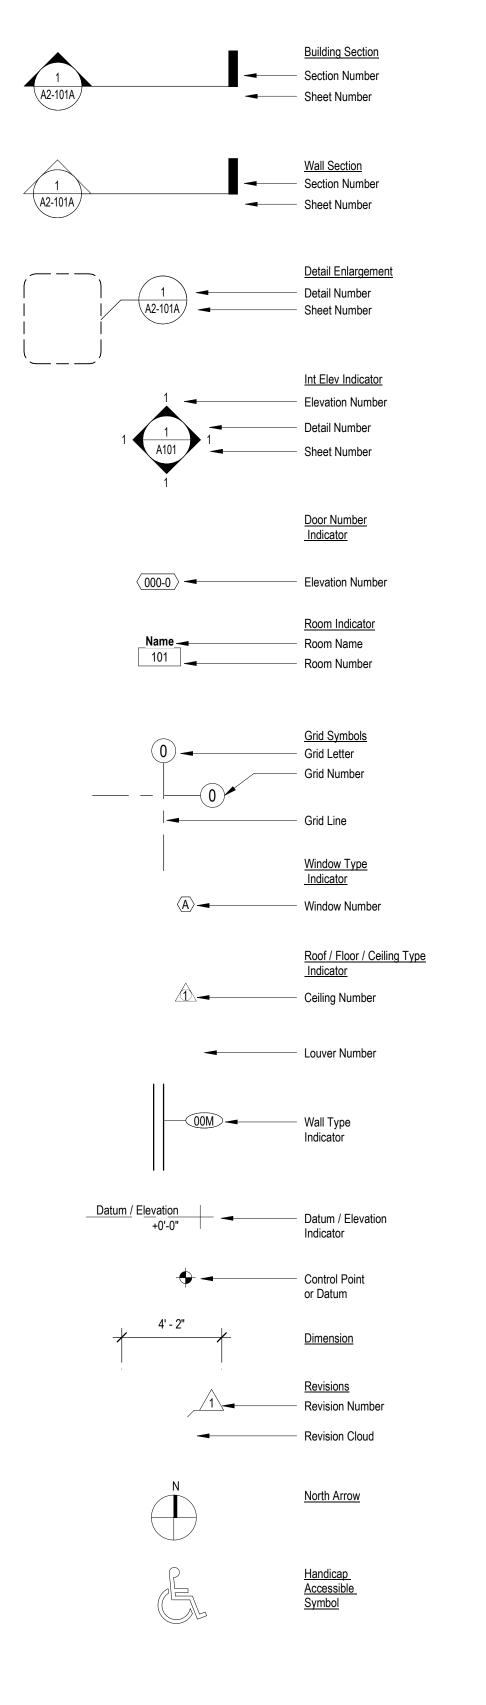
Rough Opening Riser

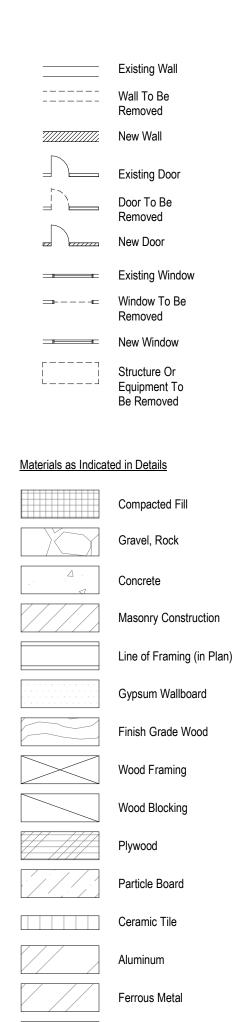
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PROJECT NO: 202203 DRAWN BY: Author CHECKED BY: Checker SCALE: As indicated

SHEET NO:







Rigid Insulation

Loose of Batt Insulation

Metal Stud Framing

---- Waterproof Membrane

1) In Many Of The Interior Spaces The Actual Dimensions May Be Less Important Than If The Two Elements In The Building Were To Be Equal. In These Cases, The Word "Equal" Or "Eq" Is Used In Lieu Of The Actual Dimensions.

2) When A Room Centerline Is Indicated Only One Side Of The Rooms Elements May Be Dimensioned.

3) Column Identification: Details Will Govern All Dimensions Not Shown On Small Scale Plans.

4) Partitions Centered On Column Or Grid Lines Will Not Be Dimensioned On Small Scale Plans But Will Be Drawn

Column Center Line

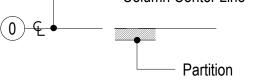
5) Partitions With A Finished Face Flush With Finish Face Of

Column Will Not Be Dimensioned On Small Scale Plans But Will

Be Drawn Accordingly. (See Note 11) Column Center Partition

Partition

6) Partitions Faced On Column or Grid Line Will Not Be Dimensioned On Small Scale Plans But Will Be Drawn Column Center Line



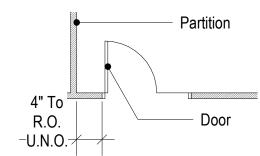
7) Openings Occurring In Partitions Or Walls:

A. When A Jamb Occurs At A Column Or Grid Line, Dimensions Will Not Be Shown On The Small Scale Plans. The Opening Width Will Be Governed By The Door Schedule

B. When A Jamb Occurs At Neither A Column Line Nor A Grid Line And Does Not Follow Typical Offsets, Then The Jamb Will Be Dimensioned.

8) Doors Are Located By One Of The Following:

A. One Jamb Face Located By A Partition At Right Angle. Typical Unless Noted Otherwise In Plan.

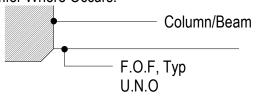


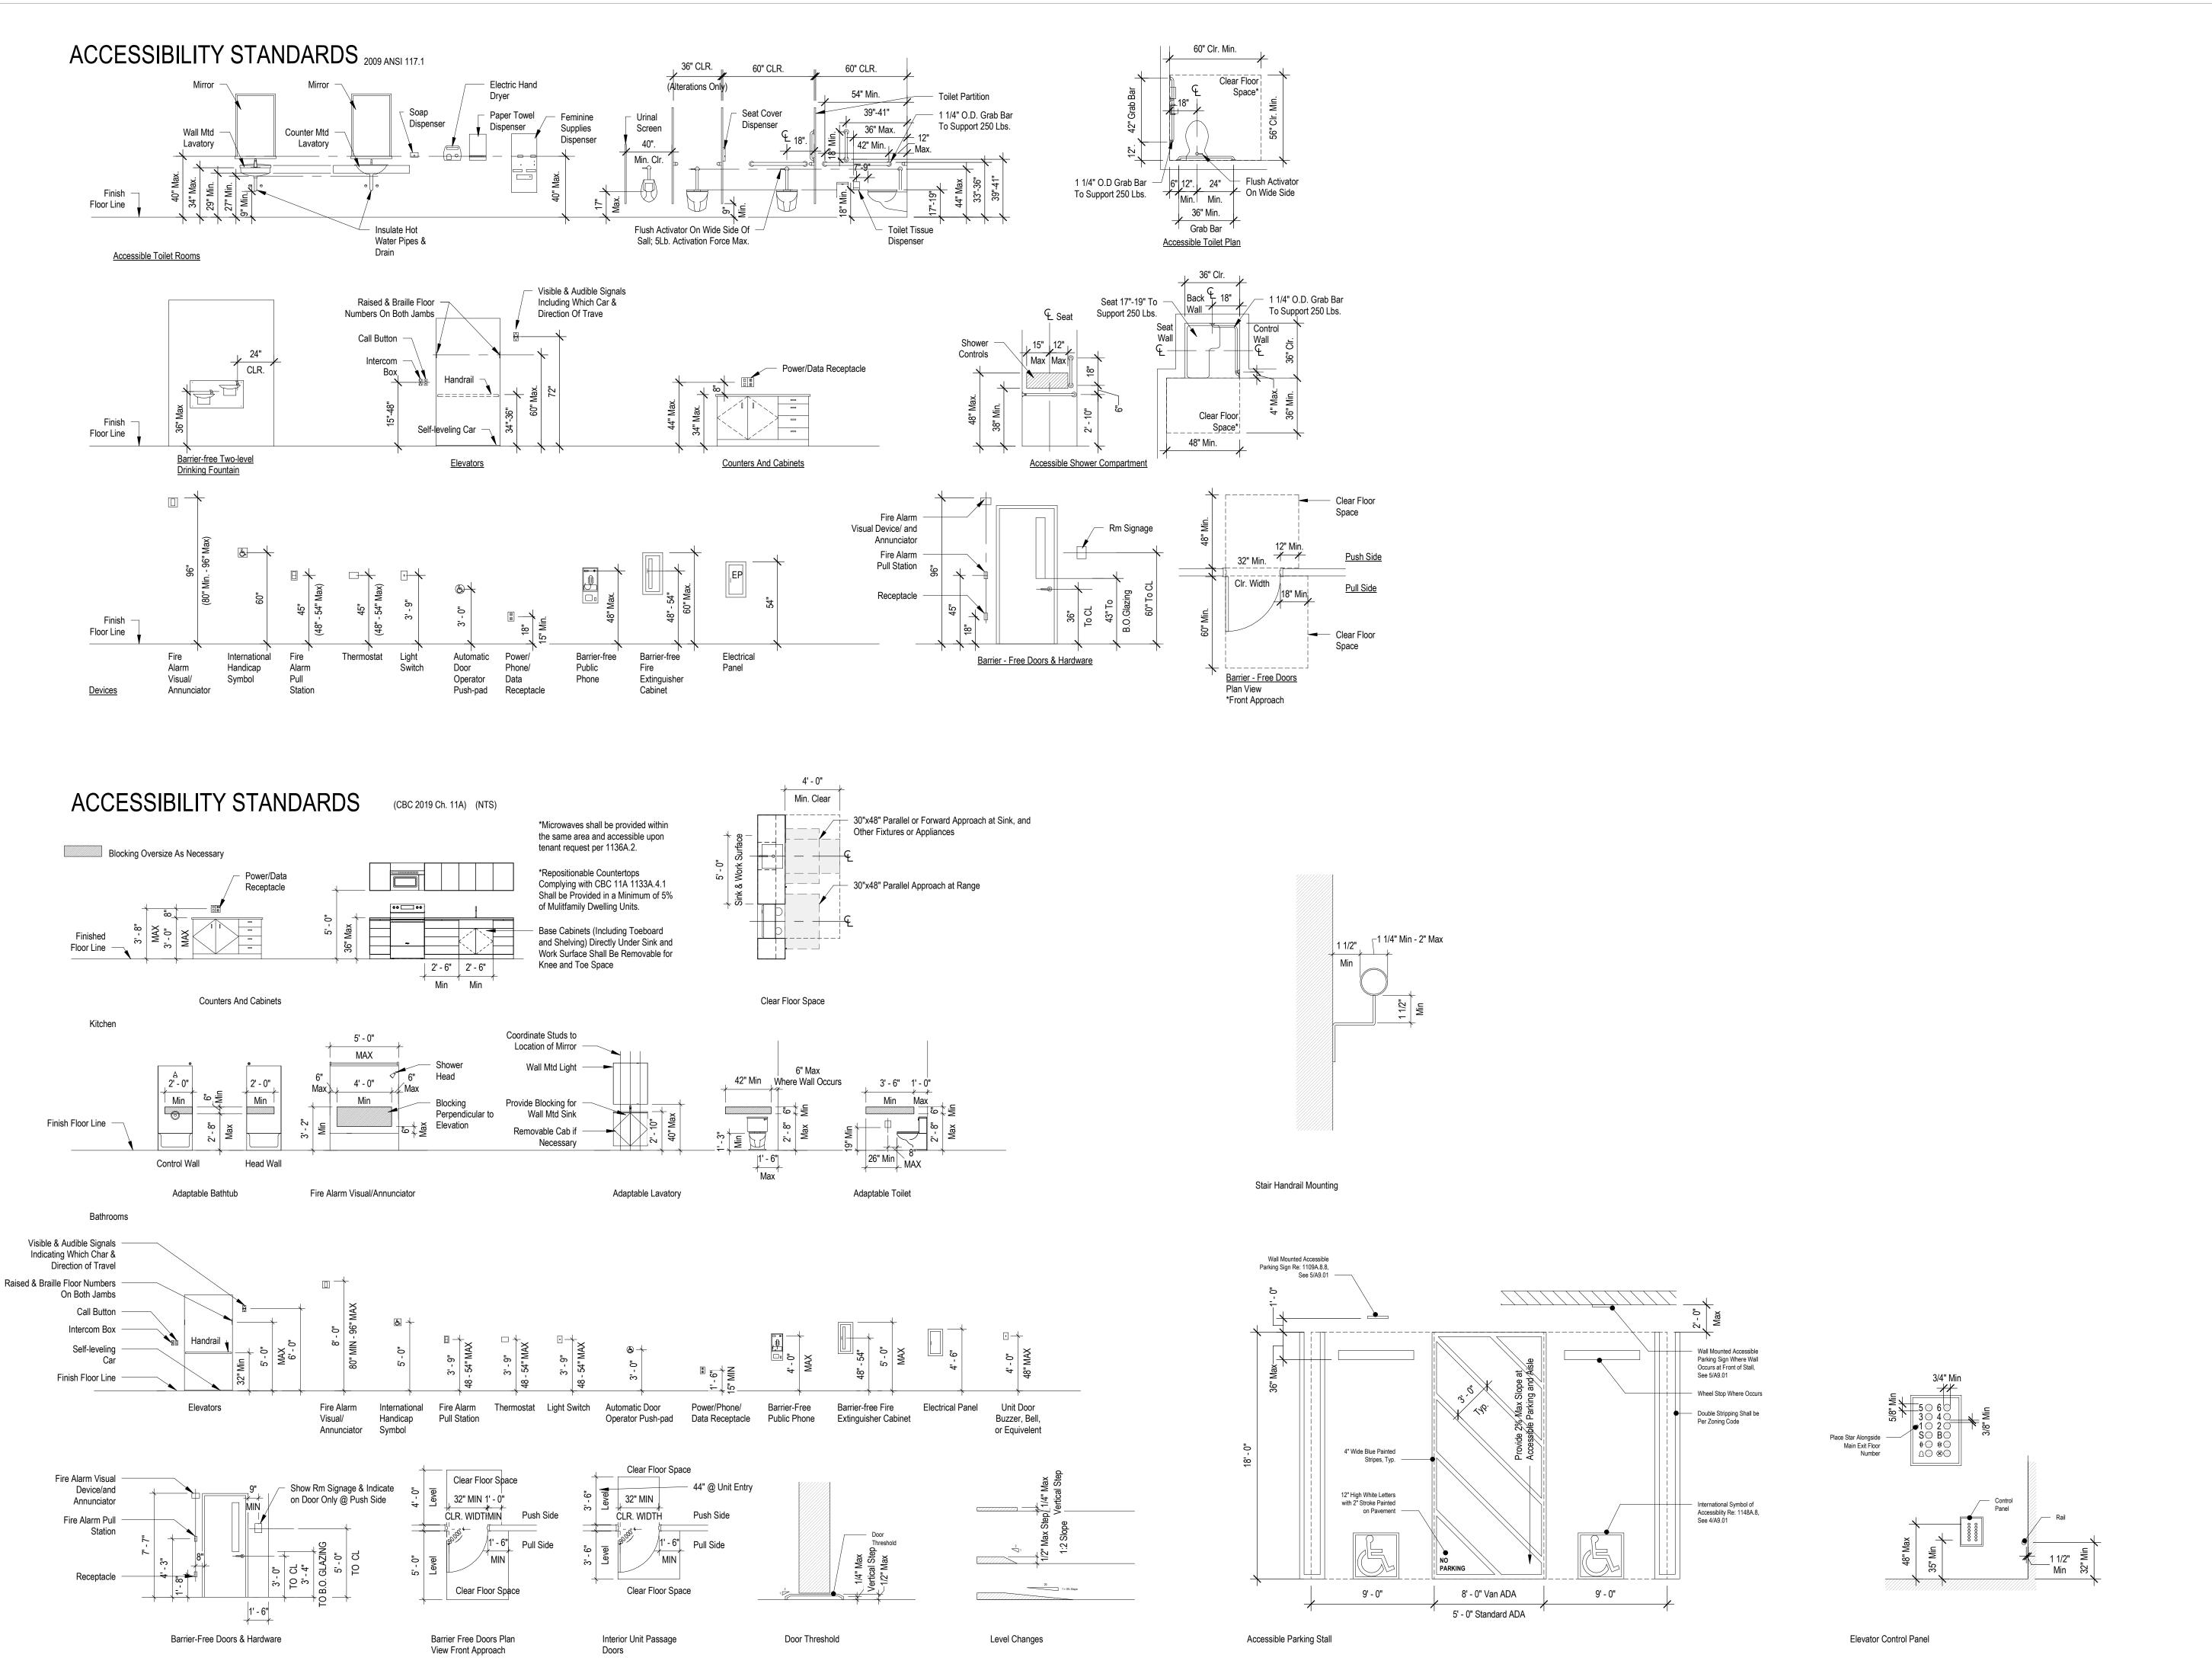
B. As Dimensioned

9) Partitions Are Dimensioned To Face of Finish Unless Noted Otherwise.

10) Dimensions Are Indicated In The Documents. The Drawings Shall Not Be Scaled For Dimensions.

11) Partitions Between Concrete Columns/Beams And Adjacent To Concrete Columns/Beams Shall Align with the Chamfer Where Occurs:





Project Description	
Project Name: San Fernando Road	Project Address: 12188 - 12192 San Fernando Road / Los Angeles, CA 91342
New Construction	Occupancy: R2 - Residential

Building Construction		
Construction Type (602): Type IIB (5 Stories)		
Building Height (Table 504.3) Building Stories (Table 504.4):	IIB Allowed: 75'-0" I 5	Proposed: 52'-5" 5 Stories
Sprinklers Used to Increase Stories (504.4): Yes	Basement: No	

Fire Resistive Requirements: Type IIB (Table 601)	Rating Required:	Rating Provided:	Tested Assembly Number:
	IIB		
Structural Frame	0 Hrs.	As Required	Refer a0.01-0.05
Bearing Walls - Exterior	1 Hrs.	As Required	Refer a0.01-0.05
Bearing Walls - Interior	0.5 Hrs.	As Required	Refer a0.01-0.05
Floor	0.5 Hrs.	As Required	Refer a0.01-0.05
Roof	0.5 Hrs.	As Required	Refer a0.01-0.05

Building Areas		Type IIB				
Allowable Areas & Area Modifications:		R-2	В	S-1	S-2	A-2
Tabular Floor Area for Each Occ. (Table 506):		UL / 48,000	UL / 69,000	UL / 52,500	UL / 78,000	UL / 28,500
Frontage Increase (506.3):	<i>l</i> =_					
Total Allowable Building Area per Story:		UL / 48,000	UL / 69,000	UL / 52,500	UL / 78,000	UL / 28,500
Proposed Areas per Story:		R-2	В	S-1	S-2	A-2
Proposed Areas per Story:		R-2	В	S-1	S-2	A-2
First Floor: Second Floor:	Type IB Type IB	7,242 SF 10,451 SF	362 SF 0 SF	1,112 SF 39 SF	1,147 SF 0 SF	1,018 SF 0 SF
Third Floor:	Type IB	10,451 SF	0 SF	39 SF	0 SF	0 SF
Fourth Floor:	Type IB	10,451 SF	0 SF	39 SF	0 SF	0 SF
Fifth Floor:	Type IB	10,451 SF	0 SF	39 SF	0 SF	0 SF
Roof:	Type IB	0 SF	0 SF	0 SF	0 SF	4,708 SF

Building Occupan	cy Classifications and Separ	rations		
Use and Occupancy Cla	ssifications (302.1): R-2, B, S-1, S-2, A	A-2		
Separated or Non-Separa	ted uses (508.2.4, 508.3 & 508.4): Sepa	rated		
R-2 to S-2 = 1 Hr	R-2 to S-1 = 1 Hr	R-2 to R-2 = 1 Hr (@ Corri)	S-2 to A-1 = 0 Hr	
R-2 to B = 1 Hr	S-1 to S-2 = 1 Hr	R-2 to R-2 = 0 Hr (Btw Units)	S-1 to B = 0 Hr	

Total Proposed Building Area (See Sheet G0.10):

Provided: Yes	Type / Class:	Required or Optional:	Areas of Coverage:
Sprinkler System:	NFPA 13	Required, 903.2	100%
Fire Alarm System:	NFPA 72	Required, 907.2.13	100%
Standpipe System:	NFPA 14	Required, 905.3	100%
Smoke Detection System:	NFPA 13	Required, 907.2.13.1	100%

4. Provide two way communication system at elevator lobbies, connected to and monitored w/ building alarm system.5. Elevators at Floors 2-5 shall be provided with smoke curtains, per manufacturers installation specification.

Floor Level:	Number o	Number of Exits: Type of Exit Required / Proposed:				Corridors (1020.1):		
	Req'd:	Prop:	Exterior Door: (1027)	Vert. Exit Encl.: (1022)	Exit Passageway: (1024)	Horizontal Exit: (1026)	Req'd	Fire Rating: (Table 1020.1)
First Floor:	2	2	Х	Х			Υ	1 Hr
Second Floor:	2	2		Х			Υ	1 Hr
Third Floor:	2	2		Х			Υ	1 Hr
Fourth Floor:	2	2		Х			Υ	1 Hr
Fifth Floor:	2	2		Х			Υ	1 Hr
Roof:	2	2		X			N	

Energy Code Requirements	(2019 California Energy Code TITLE 24, Part 6)		
Method of Energy Code Analysis: Per	formance Path		
Climate Zone: Zone 9		Path Building Type: Residential emblies (5.5-4): ription of Assembly (See Wall Types for Add'l Info) R-Value Req'd R-25 Gauge Steel Framed R-21 @ Ext. R-13 @ in R-13	
Building Envelope Requirements - Op	paque Assemblies (5.5-4):		
	Description of Assembly (See Wall Types for Add'l Info)		R-Value Req'd
Roof(s):	Attic & Other		R-25
Exterior Walls, Above Grade:	Light Gauge Steel Framed		R-21 @ Ext. R-13 @ ir
Ceilings:	Light Gauge Steel Framed		R-13
Floors:	Light Gauge Steel Framed		R-30
Ground Floor:	Unheated, Slab on Grade with Rise Pedestal (Light Gauge Ste	eel Framed Floor Assembly)	R-30

Wall Area: 23,793 sf	Window Are	ea: 3,870 sf		Glazing Fraction: 16.3%		
		max. U-Factor	max. SHGC		max. U-Factor	max. SHG
Metal Framed Storefront		0.41	0.26	Metal Entrance Assemblies	0.41	0.26
Metal Framed Operable		0.29	0.23	Vinyl Windows	0.29	0.23

Opaque Doors Non-Swinging: U-0.41

Re: a0.04 - a0.05 and specifications

Opaque Doors Swinging: U-0.29

- 1. Reference Specifications for Storefront, Door and Window Assembly Requirements.
- 2. Reference Details for Sealing of the Building Envelope Sealing and Specifications for Joint and Sealant Products
- 3. Outdoor Air Intake and Exhaust Openings to be Equipped with a Class I Motorized Leakage-Rated Damper with a Max Leakage rate of 4cfm/sf at 1.0in Water Gauge per AMCA 500D 4. Recessed Light Fixtures Between Conditioned and Unconditioned Spaces are to be Sealed to Limit Air Leakage and be IC Rated and Labeled per Specifications.

Building Mechanical Systems (503 & 504):

- Mechanical Systems Provided Under Separate Trade Permit with Tenant Improvements.
 Mechanical Systems Provided Systems to meet all Paguirements of 2010 California.
- 2. Mechanical Sub-Contractor to Provide System to meet all Requirements of 2019 California Energy Code TITLE 24.
- Building Power & Lighting Systems (505):

57,552 SF

- Electrical Systems Provided Under Separate Trade Permit with Tenant Improvements.
 Electrical Sub-Contractor to Provide System to meet all Requirements of 2019 California Energy Code TITLE 24.
- Reference Specifications for Lighting Controls Requirements
- Exterior Lighting Power Requirements & Allowances are to Be Determined with Lighting Zone 4. Reference Lighting Energy Forms.
 Interior Lighting Power Allowances and Requirements are per the Prescriptive Method. Reference Lighting Energy Forms.

Required Plum		fornia Plumbing Code 2019 Chap	pler 4		
Occupancy/Use:	Occ. Load:	Water Closets:	Lavatories:	Drinking Fountains:	Showers:
	Total:	M/F:	M/F:		
R-2	121 Dwelling Units	1 per Bathroom	1 per Bathroom	0	1 per Bathroom in Unit
	242	121	121	0	121
Total Number of Fixtu	res Provided:	121	121	0	121

Aluminum Entrance & Storefront Systems	Deferred Submittal
3. Fire Alarm / DAS System	Deferred Submittal
4. Solar Photovoltaic PV System	Deferred Submittal
5. Low Voltage System (Telephone, TV, Data Internet)	Deferred Submittal
4. HVAC Systems	Seperate Permit
5. Electrical Systems	Seperate Permit
6. Fire Spinkler & Alarm Systems	Seperate Permit
7. Exterior Building Maintainence	Seperate Permit
8. Demolition	Seperate Permit

*All Deferred Submittals Listed are Req'd to Be Stamped by the Structural Engineer of Record (SER) Prior to Submittal to the Juristiction Having Authority. Reference Structural General Notes for Deferred Submittal Requirements.

The General Contractor shall schedule a Firestopping Meeting with the Building Inspector and all Subcontractors that will be installing firestopping materials. Each Subcontractor will provide a list of Firestop materials/assemblies which will be used, the type of penetrations where each material/assembly will be used; and the listing and approval information (i.e. UL, ICC or other approved report/listing numbers.) This information must be submitted to, and approved by, the Building Inspector prior to any installation.

Code Appeals:								
	Appeal #:	Date:	Code Section:	Proposed Design:	Decision:			
1.								
2.								
3.								





Summary of Work:

Work includes construction of a light gauge steel frame 5-story building (Type IIB). The building will be 52'-5" tall, located within one half mile of a major transit stop. 100% Privately Funded. Factory-Built Housing.

The ground floor has 103 long-term and 12 short-term bike parking spaces. The multi-family housing with 121 residential units. There is a common open space at the rooftop and two stairs and an elevator access each floor.

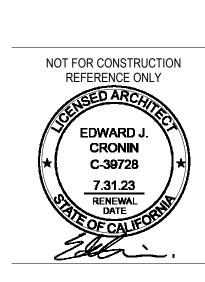
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San Fernando 12188 - 12192 San Fernando Road

Project Location & Code Summary

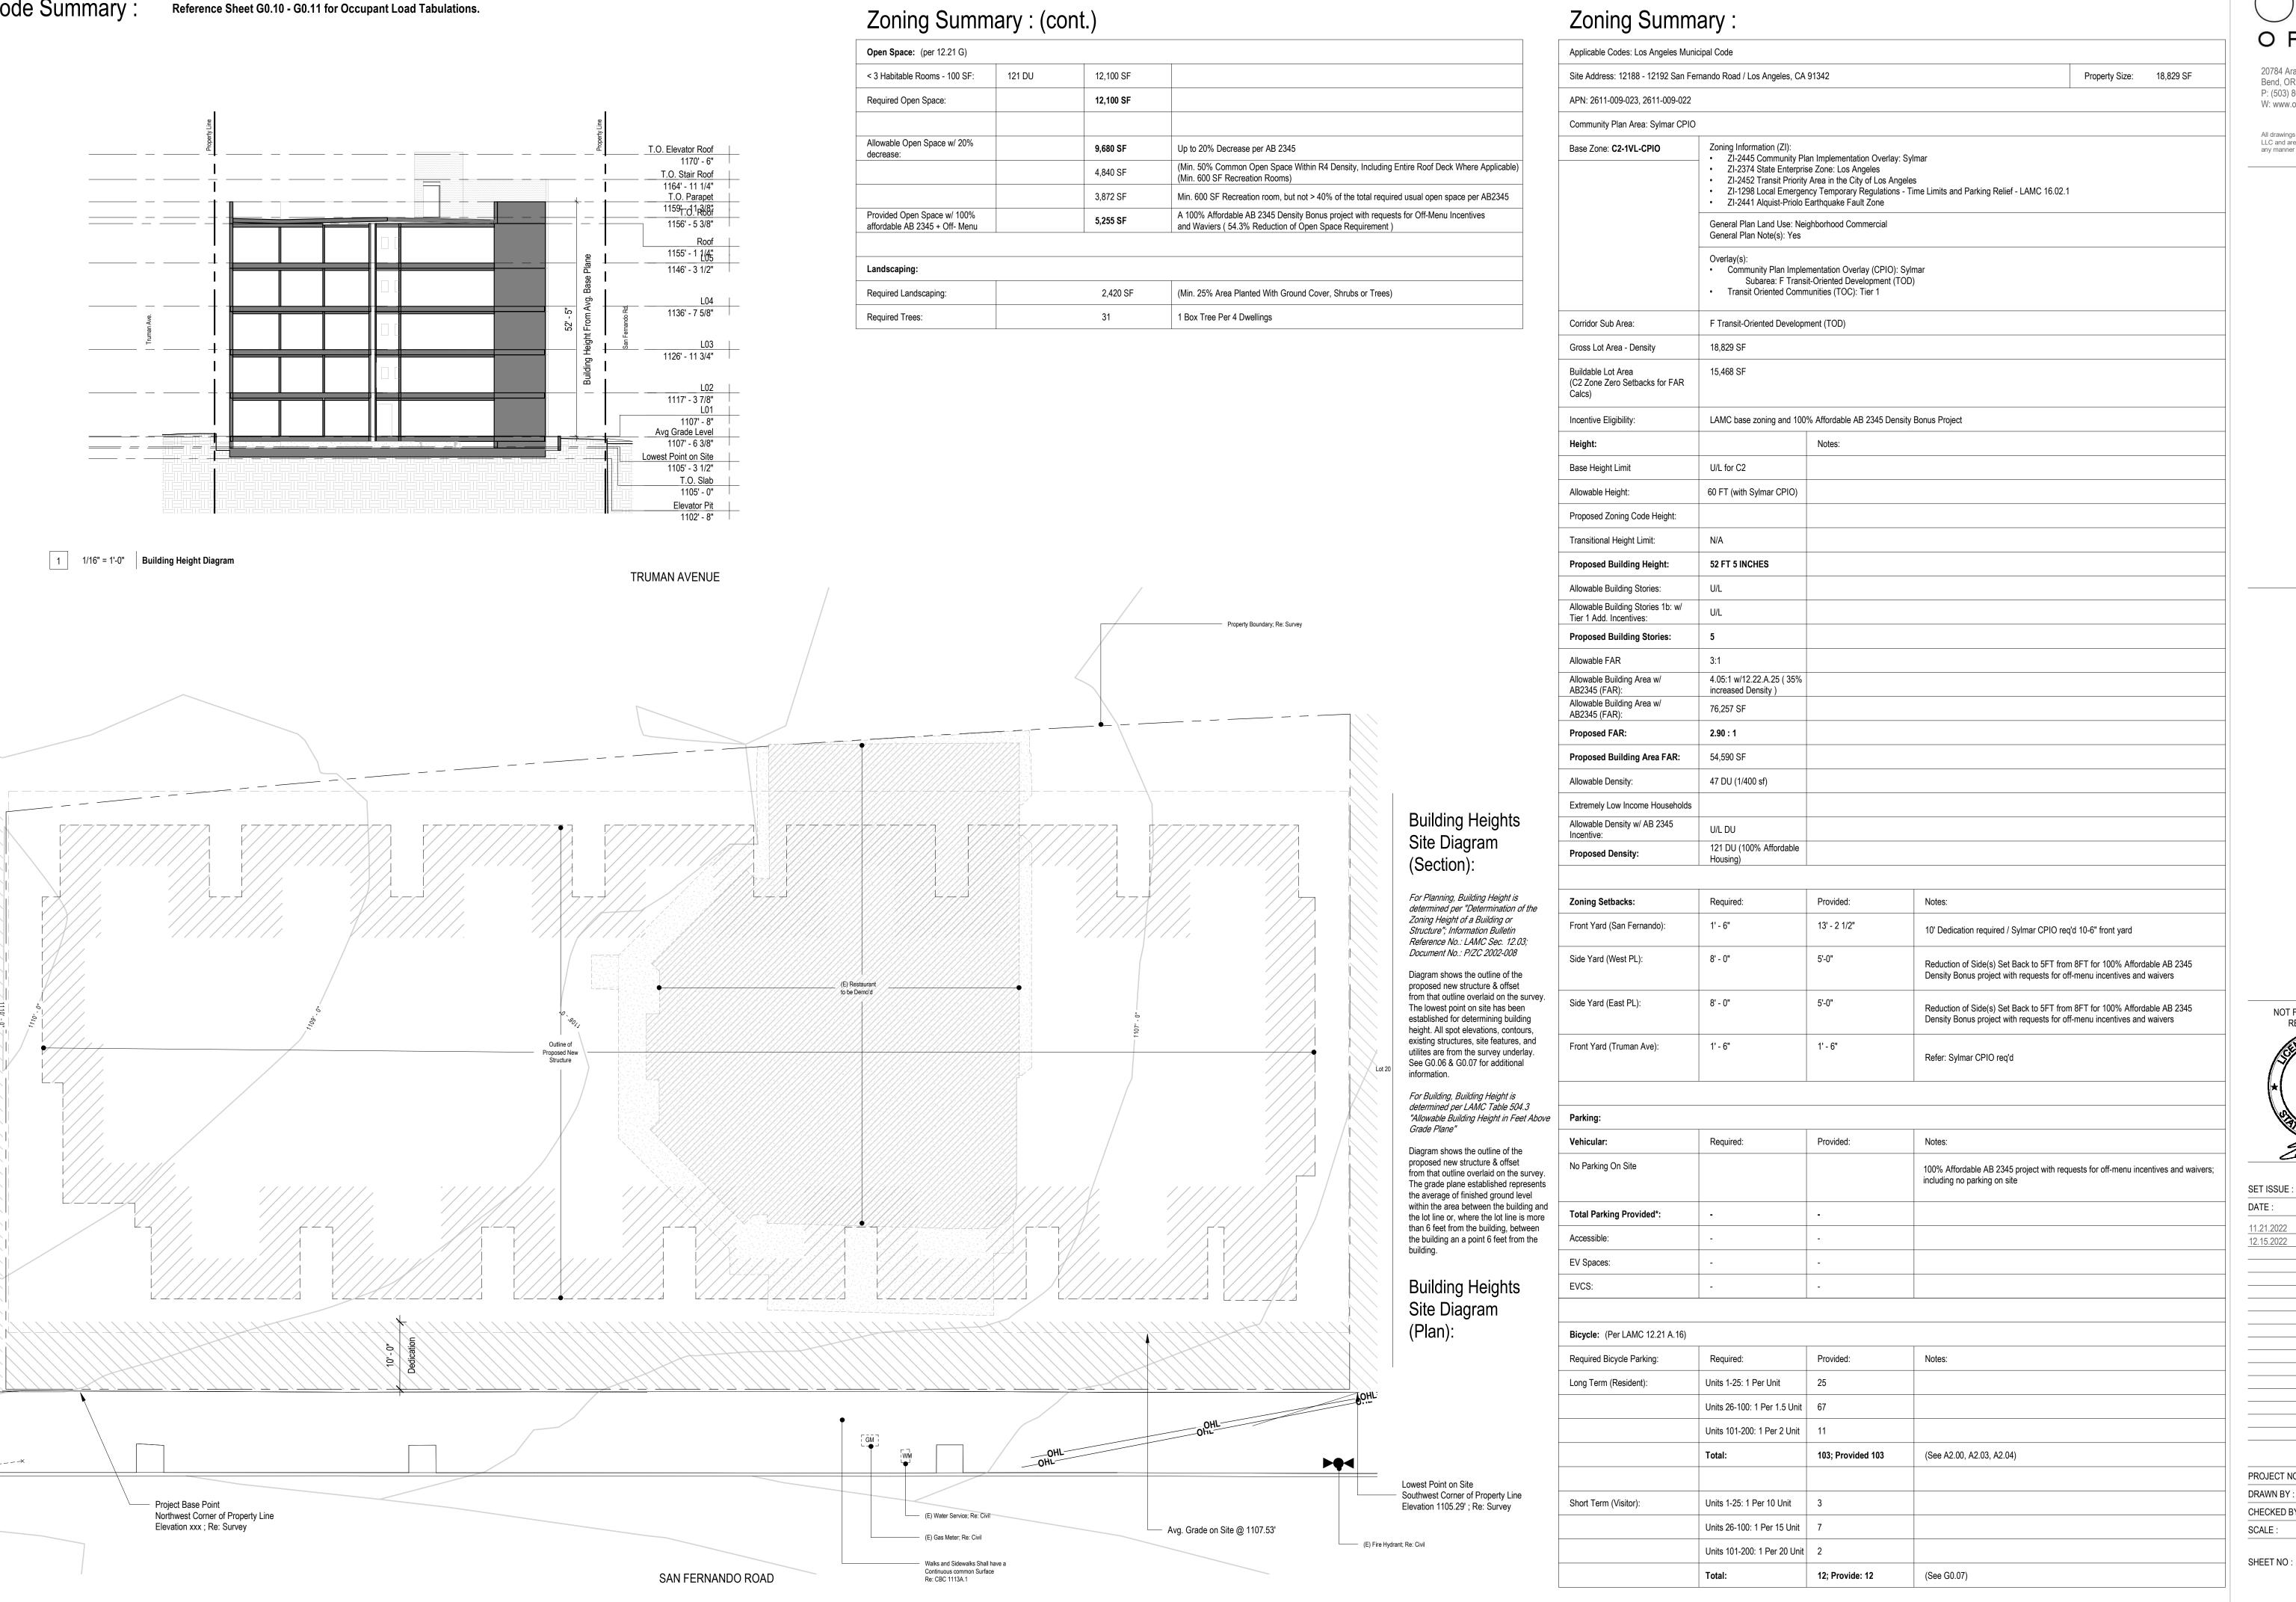


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RAWN BY :	Author
IECKED BY :	Checker
ALE :	12" = 1'-0"

SHEET NO:

30.04



2 3/32" = 1'-0" Lowest Point On Site - Diagram

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SHEET NO:

G0.05

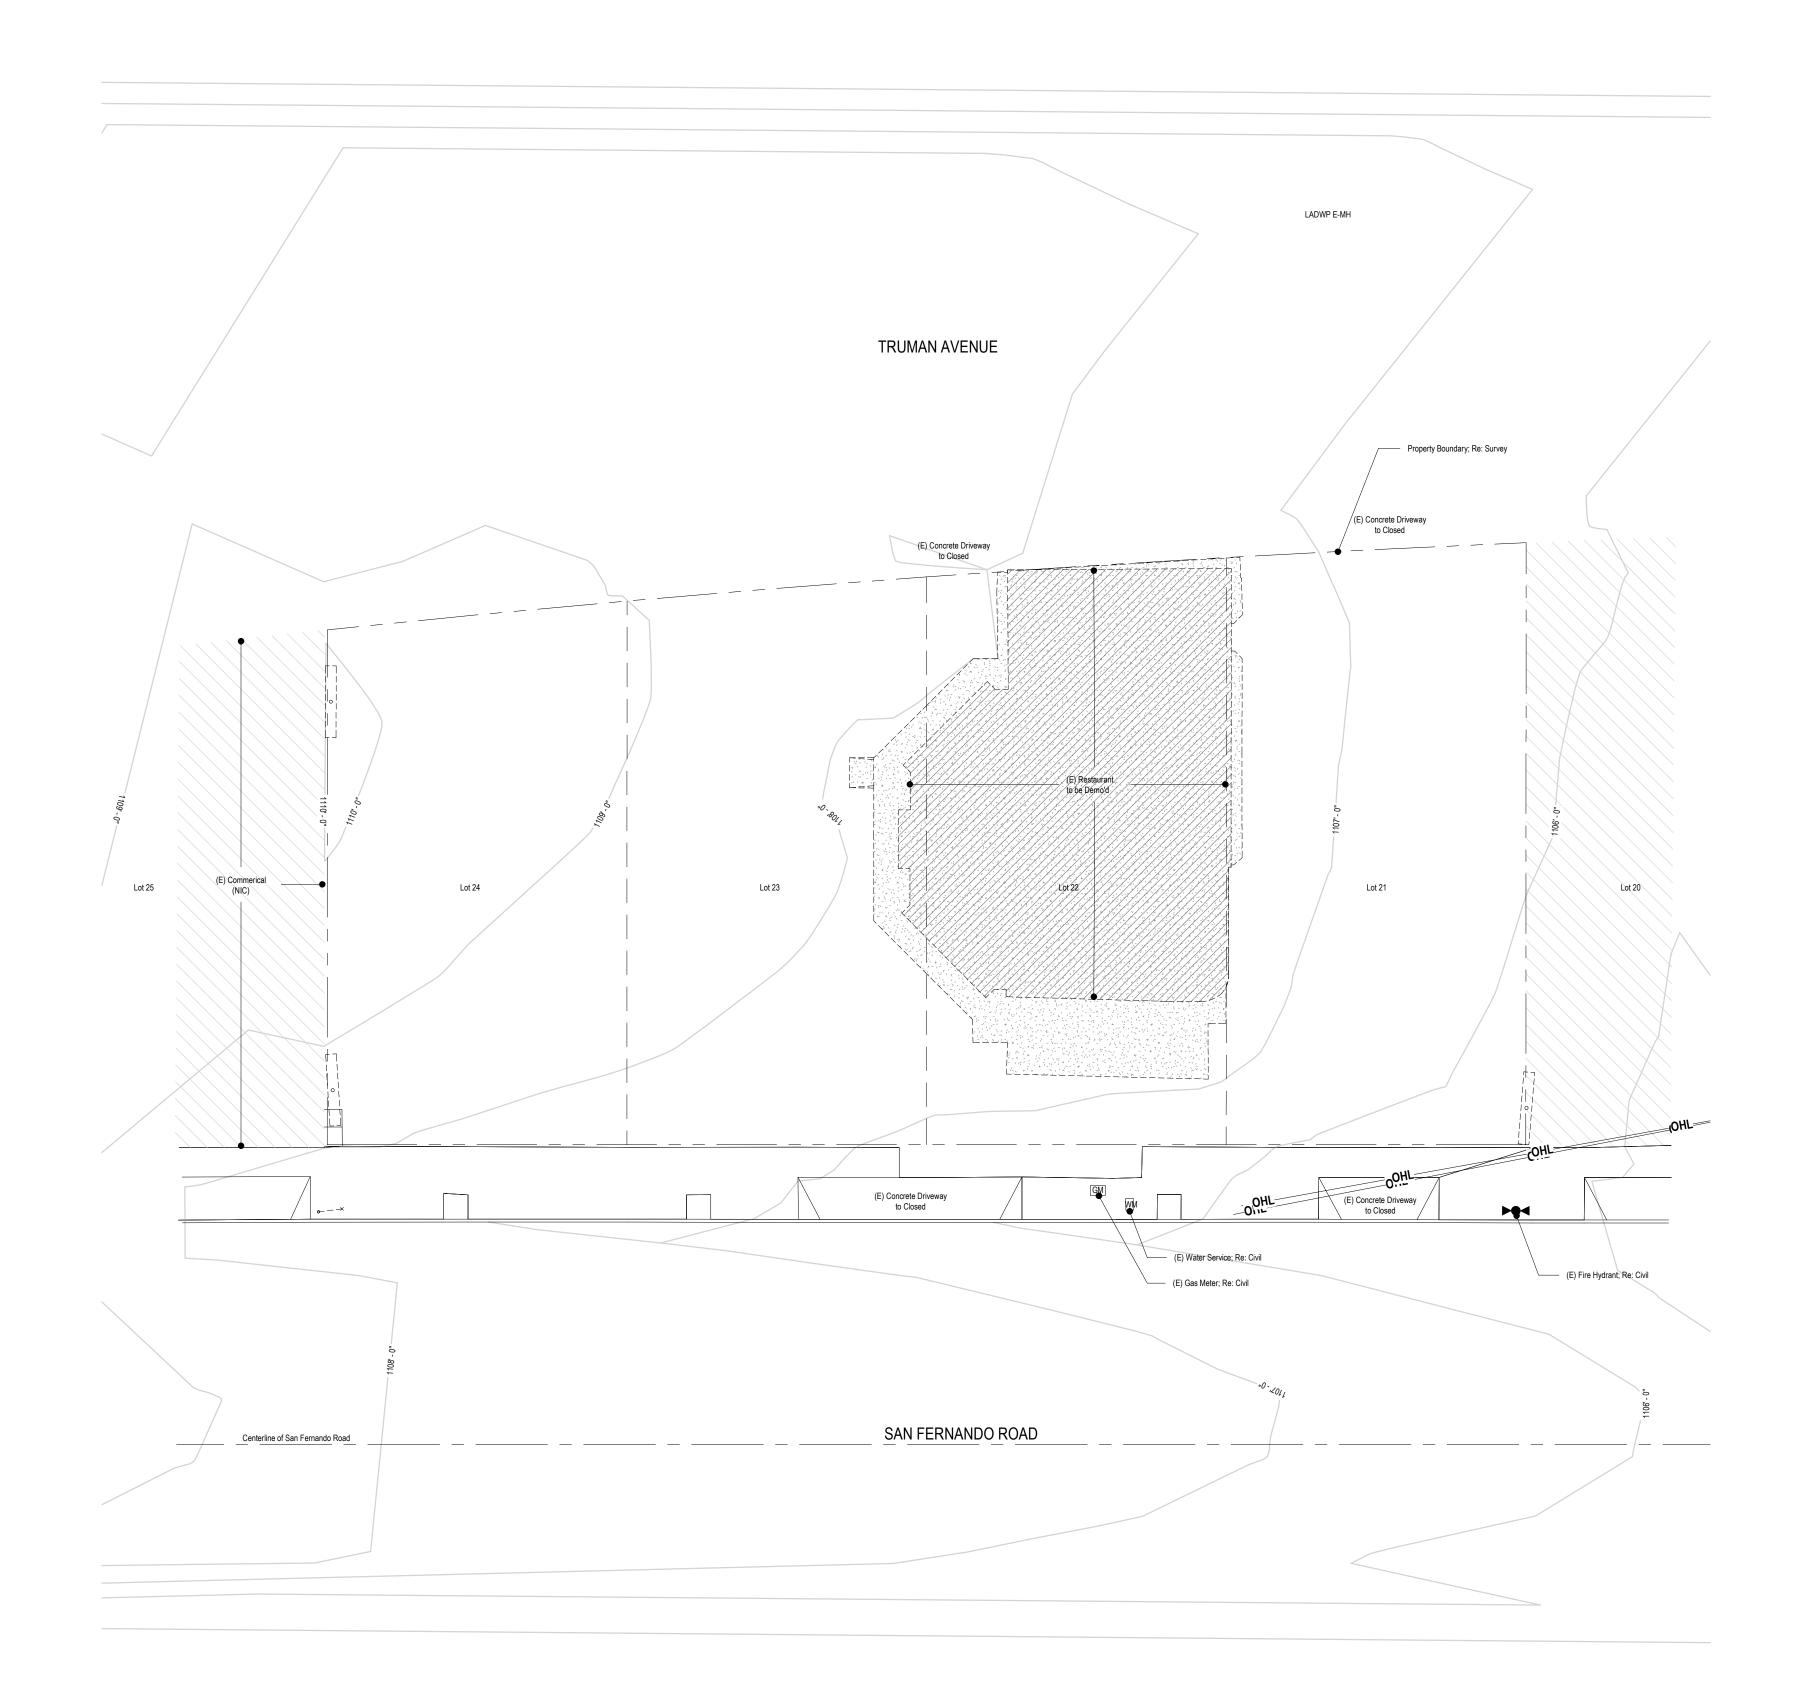
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PROJECT NO: 202203 DRAWN BY: Author CHECKED BY: Checker SCALE: As indicated

SHEET NO:



General Notes - Site Plan - Existing

Property Info:

Project Address: 12188 - 12192 San Fernando Road., Los Angeles, CA 91342

Legal Description: Lot 21, 22, 23 and 24 in Block 1 of Ross and Jones Tract in the City of Los Angeles, County of Los Angeles as per map filed in book 5 page 139 of maps, in the office of the county recorder of Los Angeles County.

Existing Site:
Existing Property/ Lot Area: 18,829 SF
Building Footprint: 3,372 SF

Building Coverage: 17.9% Proposed Site:

Existing Property/ Lot Area: 18,829 SF Building Footprint: 12,486 SF (See G0.12) Building Coverage: 66.3%

Proposed Impervious Area (Re: Civil Sheets):

- A. Total Disturbance Area: B. Existing Amount of Impervious Area:
- C. Proposed Amount of Created Impervious Area:
- D. Propsed Amount of Replaced Impervious Area:
- E. Created and/or Replaced Impervious Area in ROW: F. Total Project Impervious Area:

Note: Impervious Area May Include Rootop, Concrete Pavement, Deck, Brick, Solar Panels, Etc.

General Notes - Site Plan:

- Contractor To Verify Existing Utility Locations Prior To Construction, Typ.
 Provide Erosion Control; Re: Civil.
- 3. Reference Roof Plan For Storm Drain Locations.
- 4. Reference Foundation Plan For Under Slab Utility Locations. 5. Re: Civil for Stormwater Management Systems.
- 6. All Work Proposed in ROW Under Separate Permit.
- 7. All Disturbed Areas Must Be Stabilized with Hardscape or Landscape Prior to Final Inspection.

Legend: Site Plan Symbols

Property Line Building / Wall / Floor to Be Demolished Curb Line Water Line STM——STM——STM Storm Drain Underground Gas Line F — F Oil Pipeline -OH-----OH-----OH Overhead Line

Spot Elevation / Property Corner Note: Spot Elevations at Property Corners are Approximated from Civil Drawings Fire Hydrant

Signal Post Water Meter $\mathsf{EM} \ igsqrpu$ Electric Meter $\mathsf{GM}\ igodot$ Gas Meter

Legend: Site Plan Hatches

Zone Outside of Site Plan Extents Road or Driveway; Re: Survey

Concrete Paving in R.O.W.; Re: Survey

(E) Concrete; Re: Survey

Existing Building or Structure; Re: Survey

TRUE PLAN NORTH

General Notes - Site Plan - Proposed

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- Proposed Impervious Area (Re: Civil Sheets):
 A. Total Disturbance Area:
- B. Existing Amount of Impervious Area: C. Proposed Amount of Created Impervious Area:
- D. Propsed Amount of Replaced Impervious Area:
- E. Created and/or Replaced Impervious Area in ROW: F. Total Project Impervious Area:

Note: Impervious Area May Include Rootop, Concrete Pavement, Deck, Brick, Solar Panels, Etc.

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- 4. Reference Foundation Plan For Under Slab Utility Locations. 5. Re: Civil for Stormwater Management Systems.
- 6. All Work Proposed in ROW Under Separate Permit.
- All Disturbed Areas Must Be Stabilized with Hardscape or Landscape Prior to Final Inspection. 8. All Parking is Assigned.
- 9. When assigned parking is provided, designated accessible parking for the dwelling unit shall be provided on request of residents with disabilities on the same terms and with the full range of choices (e.g., off-street parking, carport or garage) that are available for other residents.
- 10. Any obstruction that overhangs a pedestrian way shall be a minimum of 80 inches above the walking surface as measured from the bottom of the obstruction.
- 11. Clear floor or ground spaces for wheelchairs shall be stable, firm, slip resistant, and shall comply with Section 1110A.3 or Section 1119A.2. Changes in level are not permitted. Slopes not steeper than 1:48 shall be permitted.

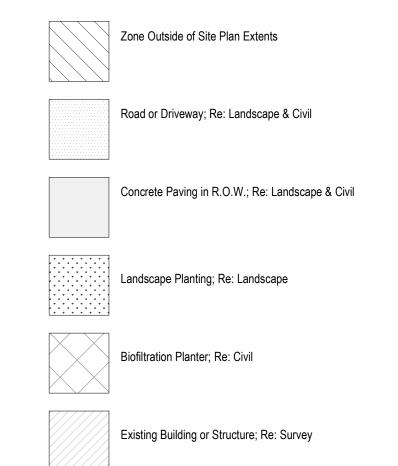
Legend: Site Plan Symbols

	Property Line
	Fence
	Lot Line
	Building / Wall / Floor to Be Demolished
	Curb Line
- W ——— W ——— W	Water Line
· s —— s —— s	Sewer Line
STM-STM-STM	Storm Drain
- G G	Underground Gas Line
· F F F	Oil Pipeline
-ОНОНОН	Overhead Line
◆	Spot Elevation / Property Corner Note: Spot Elevations at Property Corners are Approximated from Civil Drawings
▶•<	Fire Hydrant
0	Power Pole
8 ————————————————————————————————————	Signal Post
w 🖂	Water Meter
EM 🖊	Electric Meter

Gas Meter

Legend: Site Plan Hatches

GM 🔘

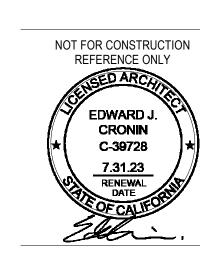




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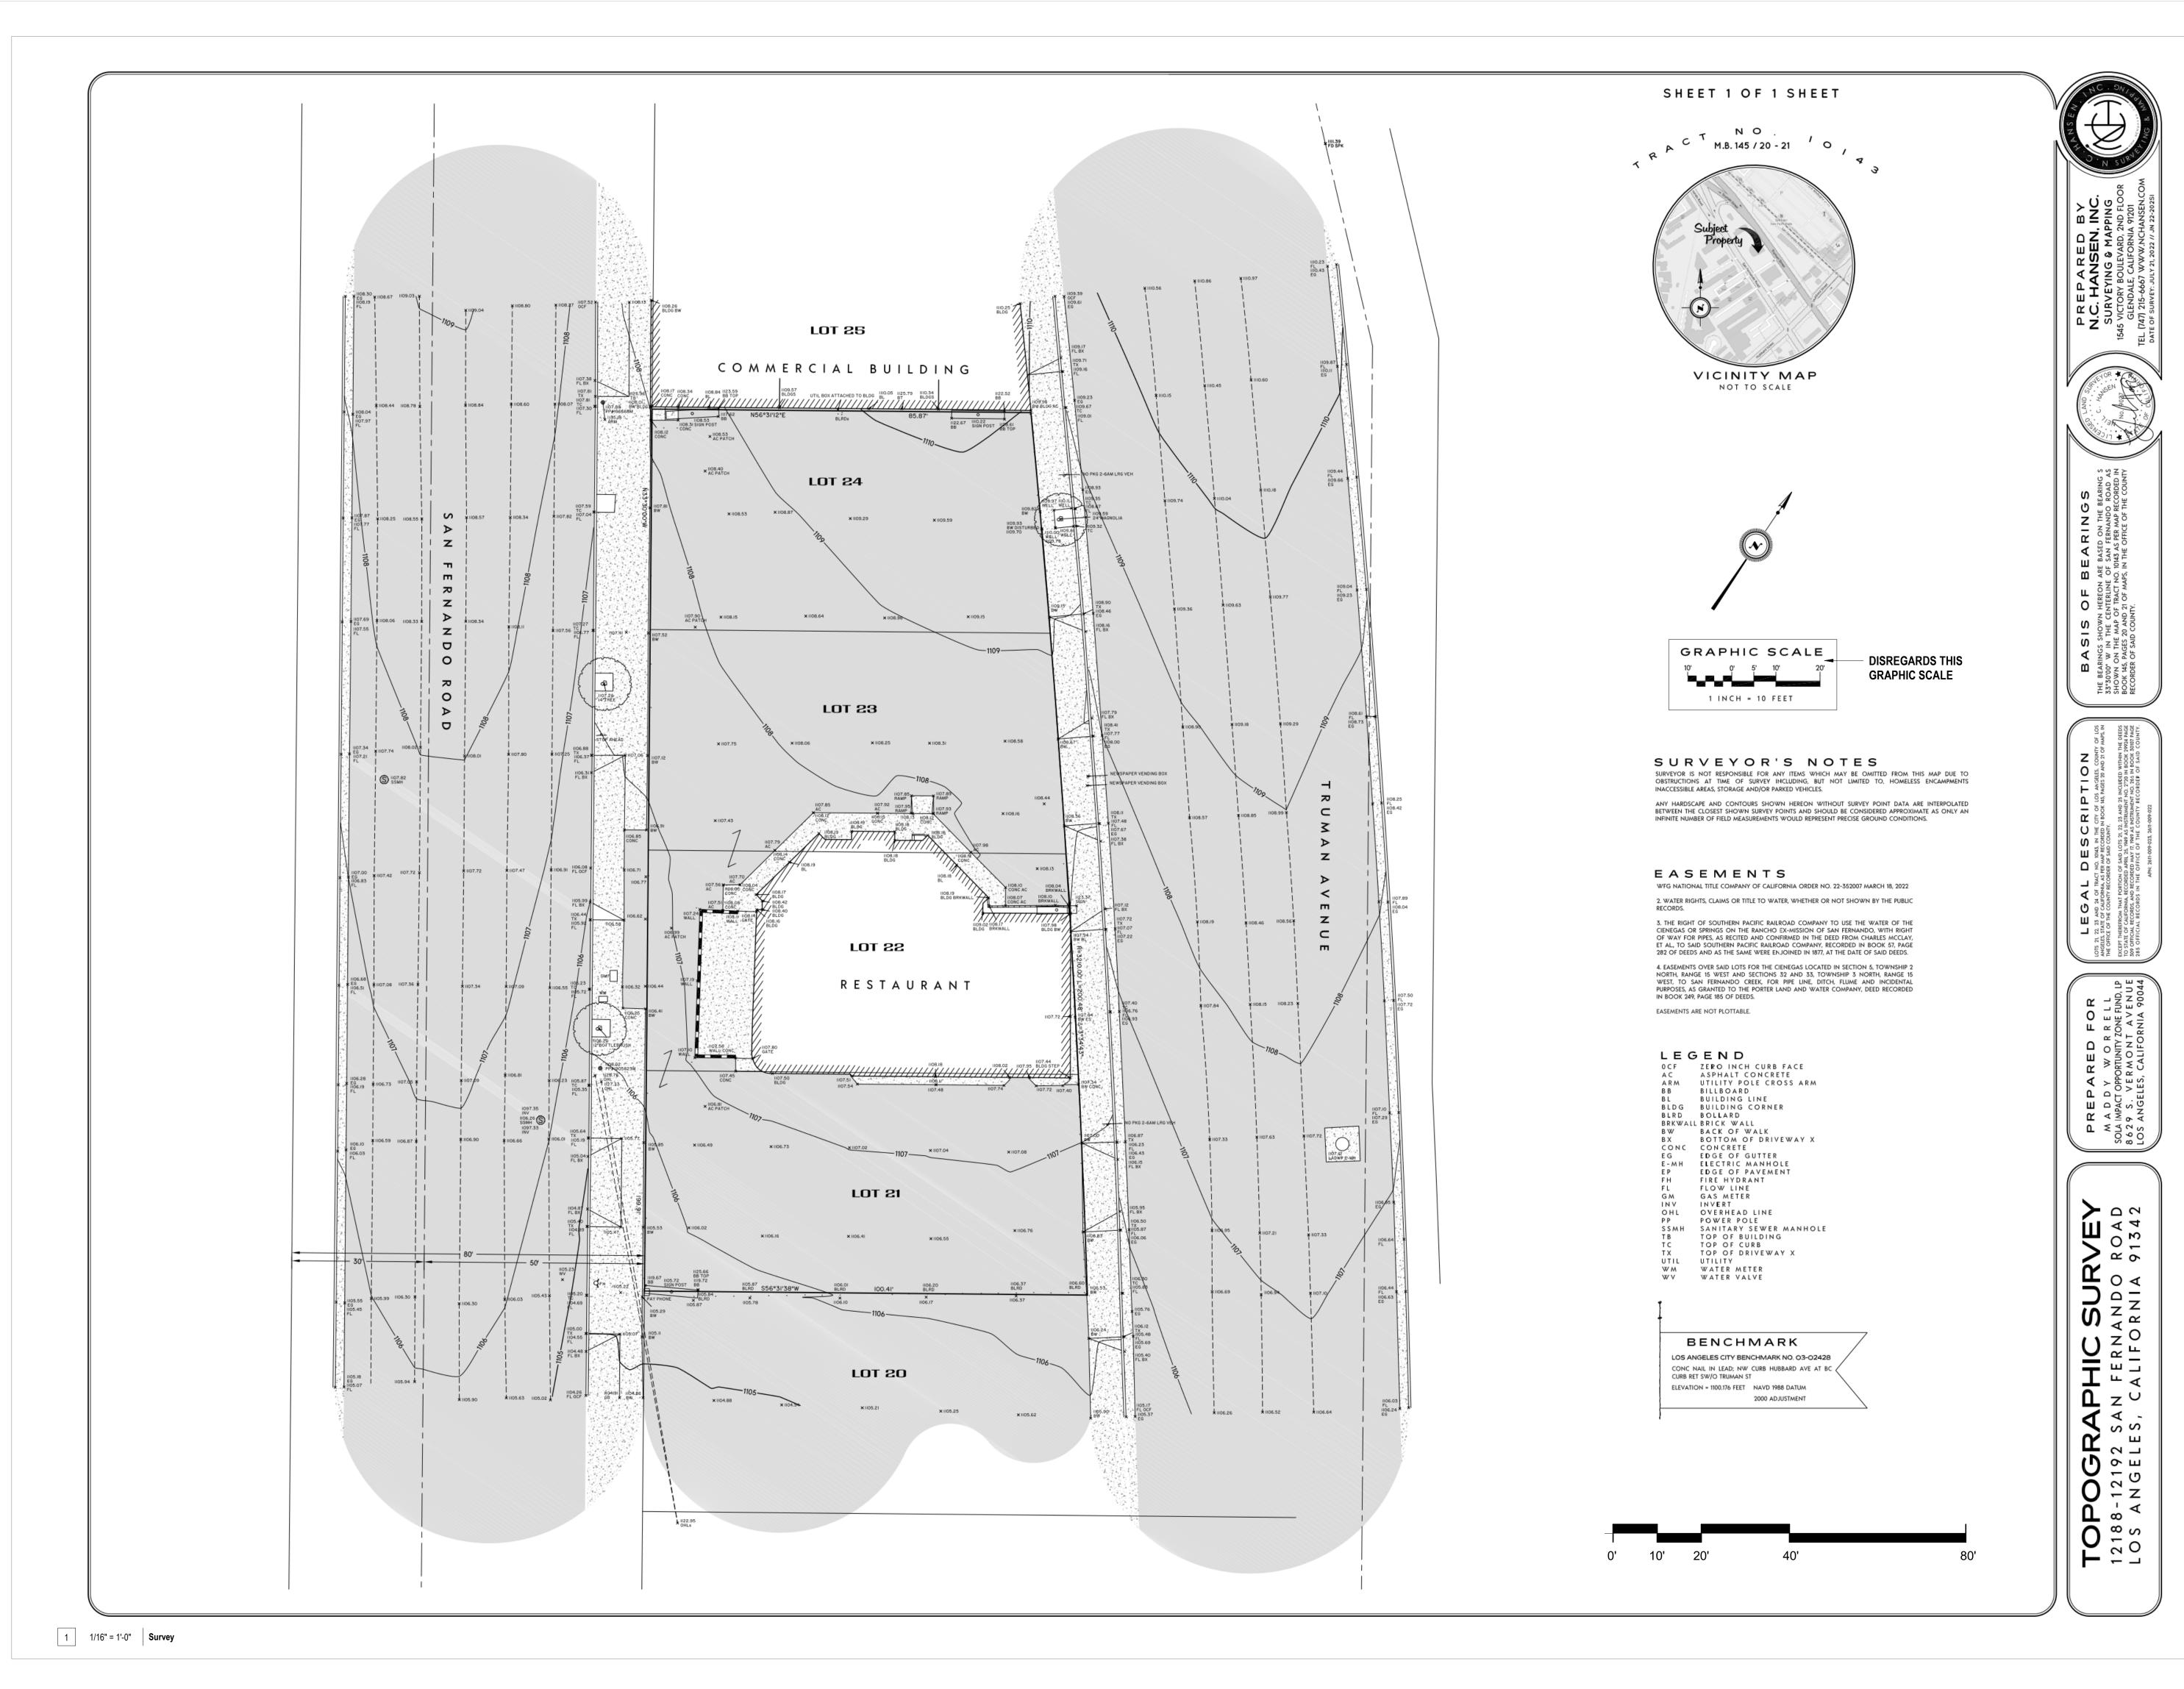


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11.21.2022	PZA Submittal
12.15.2022	1st Plan check Submitta

PROJECT NO: 202203 DRAWN BY: CHECKED BY: Checker SCALE: As indicated

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CRONIN
C-39728

7.31.23
RENEWAL
DATE
OF CALIFORNIA

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DATE : ISSUE :

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 PROJECT NO :
 202203

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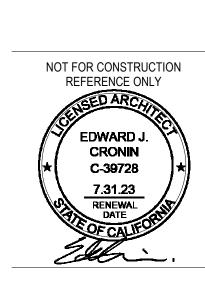
 SCALE :
 1/16" = 1'-0"

SHEET NO:

Building Occupant Load - Proposed

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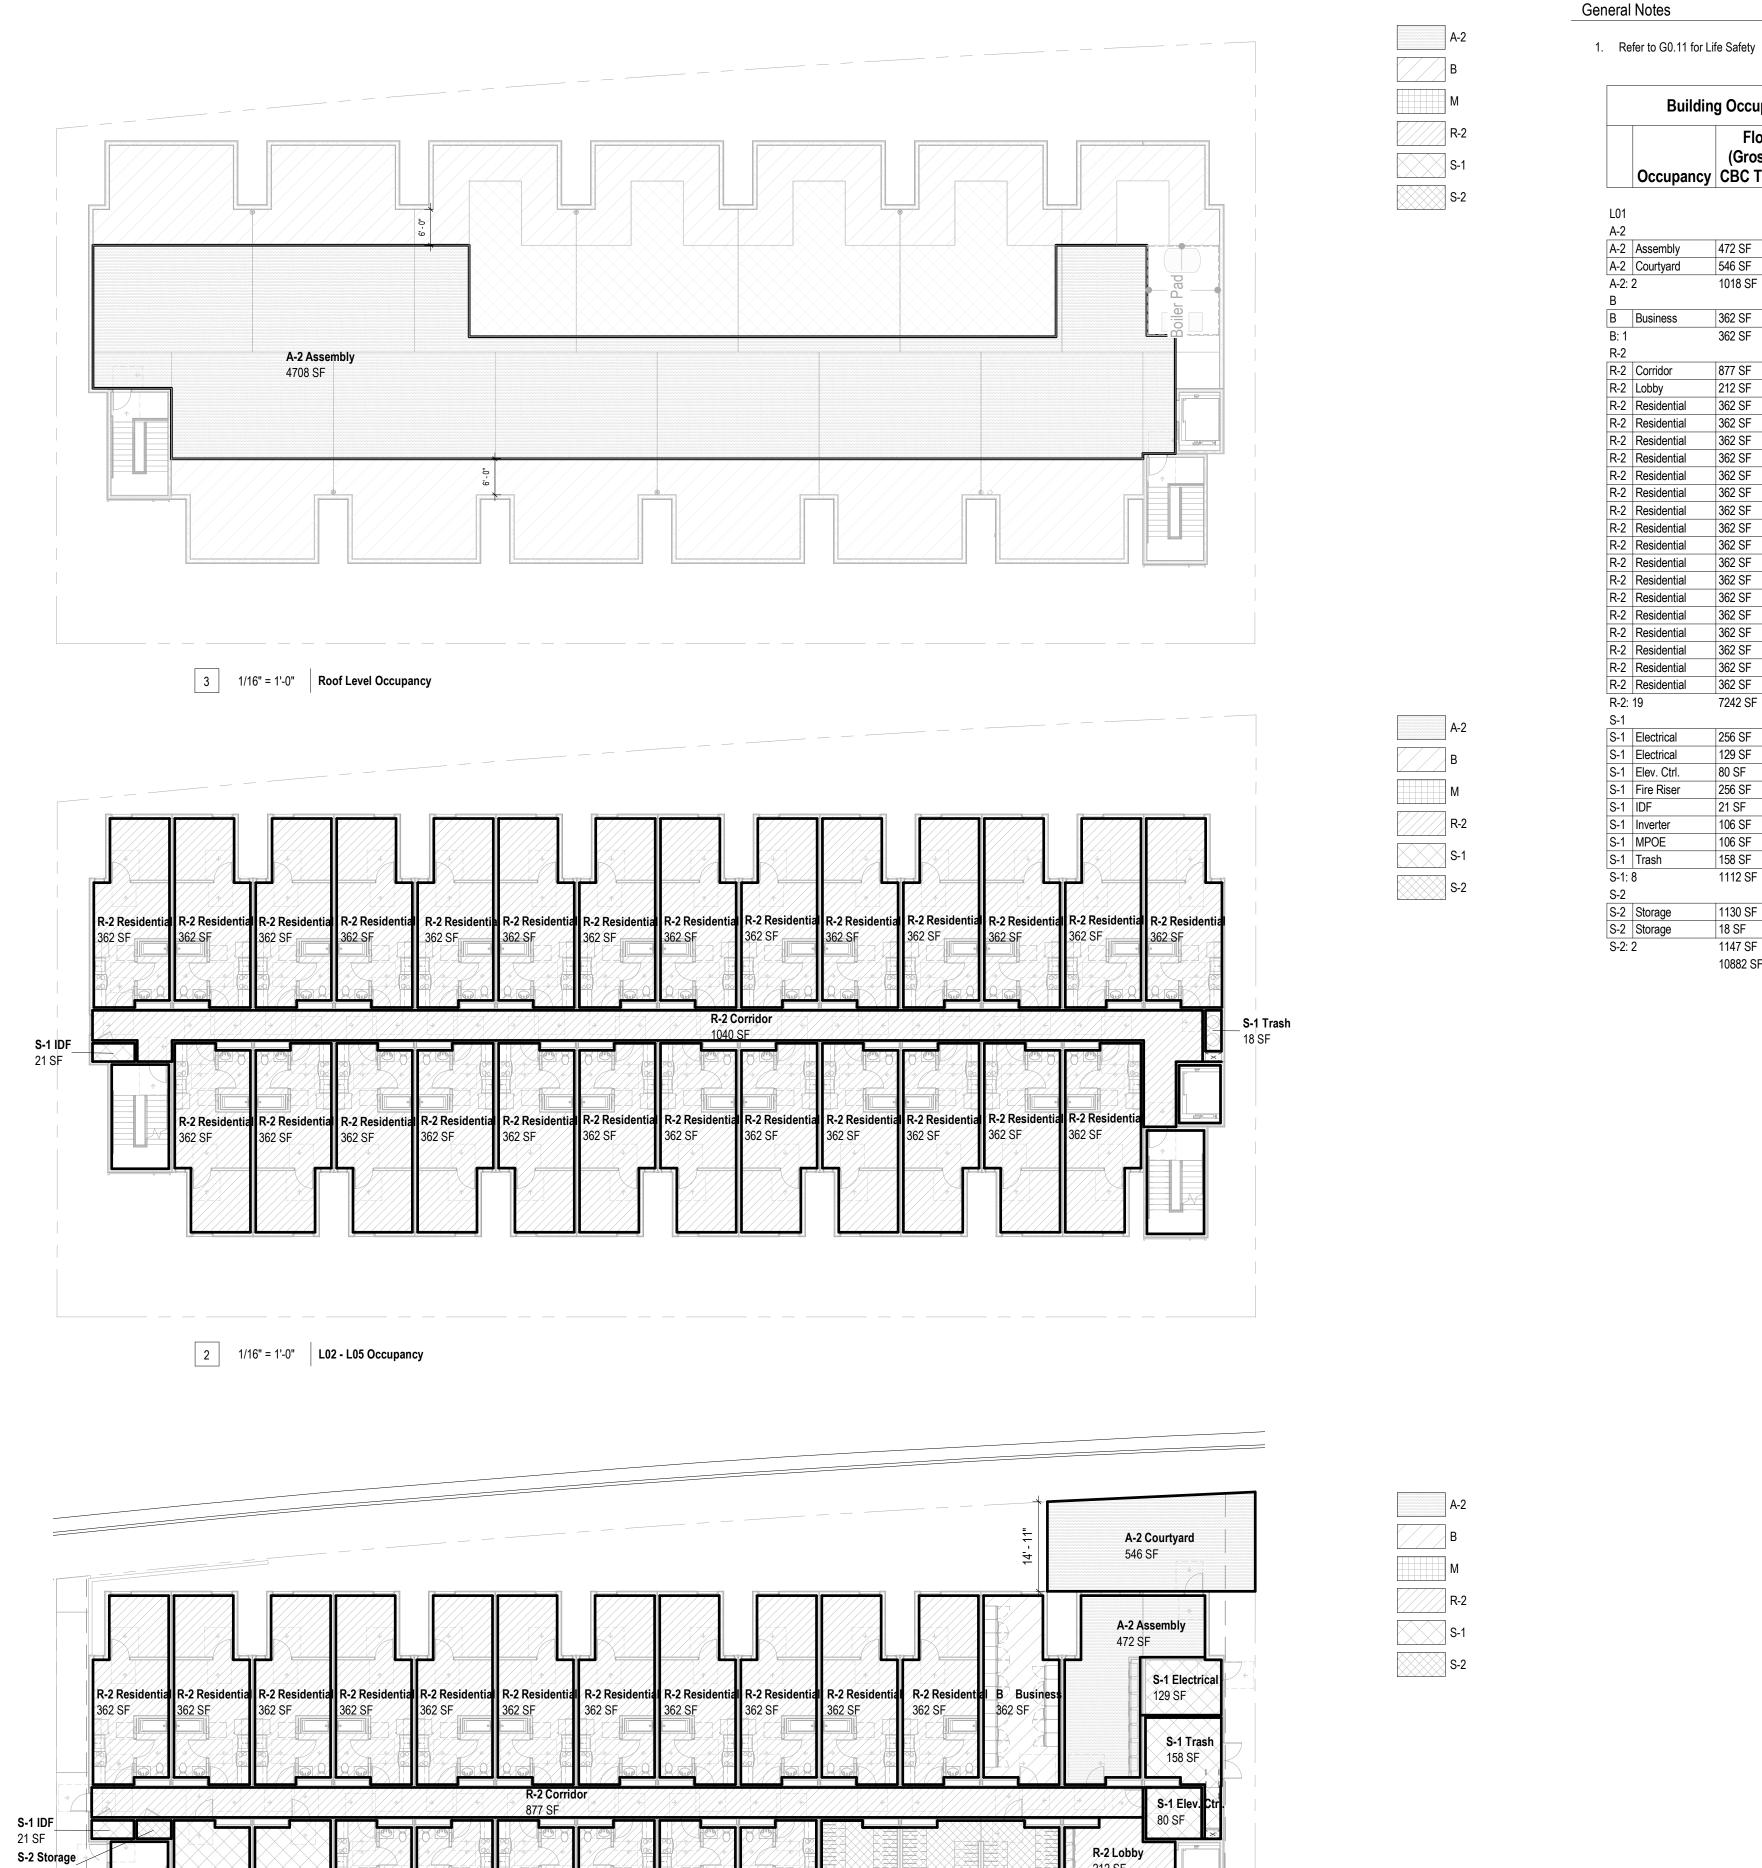


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SHEET NO:

G0.10



18 SF

S-1 Electrical S-1 Fire Riser R-2 Residentia

1 1/16" = 1'-0" **L01 Occupancy**

S-1 Inverter S-1 MPOE

R-2 Residentia R-2 Residentia R-2 Residentia R-2 Residenti

362/SF-

362 SF

362 SF

362 SF

212 SF

S-2 Storage 1130 SF

	Buildin	g Occupant Load - I	Proposed			Buildin	g Occupant Load - F	Proposed
	Occupancy	Floor Area: (Gross / Net per CBC Table 1004.5)	OccLoad Factor	Occ. Load		Occupancy	Floor Area: (Gross / Net per CBC Table 1004.5)	OccLoad Factor
.01								
					L02			
-2	Assembly	472 SF	15	32	R-2			
	Courtyard	546 SF	15	37	R-2	Corridor	1040 SF	200
\-2:	2	1018 SF		69	R-2	Residential	362 SF	200
3	I	I	1	T	R-2	Residential	362 SF	200
	Business	362 SF	150	3	R-2	Residential	362 SF	200
3: 1		362 SF		3	R-2	Residential	362 SF	200
1-2	Camidan	077.05	200		R-2	Residential	362 SF	200
R-2	Corridor	877 SF	200	0	R-2	Residential	362 SF	200
	Lobby Residential	212 SF 362 SF	200	2	R-2 R-2	Residential Residential	362 SF 362 SF	200
₹-2 ₹-2	Residential	362 SF	200	2	R-2 R-2	Residential	362 SF	200
	Residential	362 SF	200	2	R-2 R-2	Residential	362 SF	200
	Residential	362 SF	200	2	R-2 R-2	Residential	362 SF	200
	Residential	362 SF	200	2	R-2	Residential	362 SF	200
	Residential	362 SF	200	2	R-2	Residential	362 SF	200
2	Residential	362 SF	200	2	R-2	Residential	362 SF	200
-2:	19	7242 SF	1	34	R-2	Residential	362 SF	200
S-1					R-2	Residential	362 SF	200
S-1	Electrical	256 SF	300	1	R-2:	27	10451 SF	
S-1	Electrical	129 SF	300	1	S-1			
	Elev. Ctrl.	80 SF	300	1	S-1	IDF	21 SF	300
	Fire Riser	256 SF	300	1		Trash	18 SF	300
	IDF	21 SF	300	1	S-1:	2	39 SF	
	Inverter	106 SF	300	1			10491 SF	
	MPOE	106 SF	300	1				
S-1	Trash	158 SF	300	1				
S-1:	8	1112 SF		8				
3.0		1130 SF	300	4				
	Storago		JUU					
6-2			300	1		Ruildin	u ()cciinant i vad - r	Pasonor
S-2	Storage	18 SF	300	5		Buildin	g Occupant Load - F	Proposed
6-2	Storage	18 SF 1147 SF	300	5		Buildin	g Occupant Load - F	Proposed
-2 -2	Storage	18 SF	300			Buildin	-	Proposed OccLoad

Occupancy	Floor Area: (Gross / Net per CBC Table 1004.5)	OccLoad Factor	Occ. Load		Occupancy	Floor Area: (Gross / Net per CBC Table 1004.5)	OccLoad Factor	Occ. Load		Occupancy	Floor Area: (Gross / Net per CBC Table 1004.5)	OccLoad Factor	Occ. Load
				L02					L04				
Assembly	472 SF	15	32	R-2					R-2				
Courtyard	546 SF	15	37	R-2	Corridor	1040 SF	200	0	R-2	Corridor	1040 SF	200	0
<u>)</u>	1018 SF		69	R-2	Residential	362 SF	200	2	R-2	Residential	362 SF	200	2
				R-2	Residential	362 SF	200	2	R-2	Residential	362 SF	200	2
Business	362 SF	150	3	R-2	Residential	362 SF	200	2	R-2	Residential		200	2
	362 SF		3	R-2		362 SF	200	2	R-2	Residential		200	2
				R-2	Residential	362 SF	200	2	R-2			200	2
Corridor		200	0	R-2		362 SF	200	2				200	2
Lobby	212 SF	200	0	R-2		362 SF	200	2		Residential		200	2
Residential	362 SF	200	2	R-2		362 SF	200	2		Residential		200	2
Residential	362 SF	200	2	R-2	Residential	362 SF	200	2	R-2	Residential		200	2
Residential	362 SF	200	2	R-2	Residential	362 SF	200	2	R-2	Residential		200	2
Residential	362 SF	200	2	R-2	_	362 SF	200	2	R-2	Residential		200	2
Residential	362 SF	200	2	R-2		362 SF	200	2	R-2	Residential		200	2
Residential	362 SF	200	2	R-2	Residential	362 SF	200	2	R-2			200	2
Residential	362 SF	200	2	R-2		362 SF	200	2		Residential		200	2
Residential	362 SF	200	2	R-2		362 SF	200	2	R-2	Residential		200	2
Residential	362 SF	200	2	R-2		362 SF	200	2	R-2	Residential		200	2
Residential	362 SF	200	2	R-2		362 SF	200	2				200	2
Residential	362 SF	200	2	R-2		362 SF	200	2	R-2	Residential		200	2
Residential	362 SF	200	2	R-2	Residential	362 SF	200	2	R-2	Residential		200	2
Residential	362 SF	200	2	R-2	Residential	362 SF	200	2	R-2	Residential		200	2
Residential	362 SF	200	2	R-2	Residential	362 SF	200	2	R-2	Residential		200	2
Residential	362 SF	200	2	R-2	Residential	362 SF	200	2	R-2	Residential		200	2
Residential	362 SF	200	2	R-2		362 SF	200	2	-	Residential		200	2
Residential	362 SF	200	2	R-2		362 SF	200	2				200	2
19	7242 SF		34		Residential	362 SF	200	2				200	2
					Residential		200	2				200	2
Electrical	256 SF	300	1	R-2		10451 SF		52	R-2:	27	10451 SF		52
Electrical		300	1	S-1		_			S-1				
Elev. Ctrl.	80 SF	300	1		IDF		300	1	S-1			300	1
Fire Riser	256 SF	300	1		Trash	18 SF	300	1		Trash		300	1
IDF	21 SF	300	1	S-1	: 2	39 SF		2	S-1:		39 SF		2
Inverter	106 SF	300	1			10491 SF		54			10491 SF		54
MPOE	106 SF	300	1										
Trash	158 SF	300	1										
3	1112 SF		8										
Storage	1130 SF	300	4										
Storage	18 SF	300	1		Buildin	g Occupant Load - F	Proposed			Building	g Occupant Load - F	Proposed	
)	1147 SF	1	5				-				<u> </u>	-	
	10882 SF		119			Floor Area:	Ocal co-l	000			Floor Area:	0001 000	0.55

		(Oloss / Net per		OCC.			(Oloss / Net per		
	Occupancy	CBC Table 1004.5)	Factor	Load		Occupancy	CBC Table 1004.5)	Factor	Lo
							-		
_03					L05				
R-2					R-2				
	Corridor	1040 SF	200	0		Corridor	1040 SF	200	0
	Residential	362 SF	200	2		Residential	362 SF	200	2
	Residential	362 SF	200	2		Residential	362 SF	200	2
	Residential	362 SF	200	2		Residential	362 SF	200	2
	Residential	362 SF	200	2		Residential	362 SF	200	2
	Residential	362 SF	200	2		Residential	362 SF	200	2
		362 SF	200	2		Residential	362 SF	200	2
	Residential	362 SF	200	2	R-2		362 SF	200	2
	Residential	362 SF	200	2		Residential	362 SF	200	2
	Residential	362 SF	200	2		Residential	362 SF	200	2
		362 SF	200	2		Residential	362 SF	200	2
	Residential	362 SF	200	2	R-2		362 SF	200	2
	Residential	362 SF	200	2		Residential	362 SF	200	2
	Residential	362 SF	200	2		Residential	362 SF	200	2
	Residential	362 SF	200	2		Residential	362 SF	200	2
	Residential	362 SF	200	2	R-2		362 SF	200	2
	Residential	362 SF	200		R-2		362 SF	200	2
		362 SF		2			362 SF	200	2
	Residential		200	2		Residential			
	Residential	362 SF	200	2		Residential	362 SF	200	2
	Residential	362 SF	200	2		Residential	362 SF	200	2
	Residential	362 SF	200	2		Residential	362 SF	200	2
	Residential	362 SF	200	2		Residential	362 SF	200	2
	Residential	362 SF	200	2		Residential	362 SF	200	2
	Residential	362 SF	200	2			362 SF	200	2
	Residential	362 SF	200	2		Residential	362 SF	200	2
	Residential	362 SF	200	2		Residential	362 SF	200	2
	Residential	362 SF	200	2		Residential	362 SF	200	2
R-2:	27	10451 SF		52	R-2:	27	10451 SF		52
S-1	1	ı	1		S-1	1	ı		
	IDF	21 SF	300	1	S-1		21 SF	300	1
	Trash	18 SF	300	1		Trash	18 SF	300	1
S-1:	2	39 SF		2	S-1:	2	39 SF		2
		10491 SF		54			10491 SF		54

(Gross / Net per OccLoad Occ.

	Occupancy	(Gross / Net per CBC Table 1004.5)	OccLoad Factor	Occ.
		Floor Area:		
	Buildin	g Occupant Load - I	Proposed	
		10491 SF		54
S-1:	2	39 SF		2
S-1	Trash	18 SF	300	1
S-1	IDF	21 SF	300	1

(Gross / Net per OccLoad Occ.

	Cocapancy	ODO TUDIO TO	7.0) I dotoi	
			·	
Roof				
A-2				
A-2	Assembly	4708 SF	15	294
A-2:	1	4708 SF		294
		4708 SF		294
Occu Floor	ipant Load All 's	57552 SF		629

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 Utility
 Unit
 Unit

1 1/16" = 1'-0" **L01 - Egress Plan**

General Notes

- 1. All Exit Signs, Egress & Emergency Lighting Per Deferred Design-Build Submittal. 2. All Fire Detection, Sprinkler And Alarm Systems Per Deferred Design Build Submittal.
- 3. Refer To Specifications For Deferred Bidder Design Submittal Requirements For Sprinkler And Standpipe Systems, Emergency Lighting, Exit Signs And Fire Detection Systems.
- 4. A Tactile Sign Stating EXIT and complying with ICC A117.1 Shall be Provided Adjacent to
- Each Door to an Egress Stairway, an Exit Passageway and the Exit Discharge. 5. Reference sheet G0.10 for occupancy plans and occupant load summary.
- 6. Reference sheet A0.10-A0.12 for Door Schedule and Opening Requirements. 7. General Contractor shall schedule a pre-installation conference with the building inspector to review proposed fire stopping products for the project. Prior to the scheduled meeting the general contractor shall assemble product data for each firestopping assembly with UL test
- report for each proposed assembly. 8. Provide Automatic Sprinkler System Throughout in Accordance with NFPA 13.
- 9. Provide Two-Way Communication System at Elevator Lobbies, Connected to and Monitored by Building Alarm System.
- 10. Penetrations Into and Through Interior Exit Stairway Walls Are Prohibited, Except: A. Equipment and Ductwork Necessary for Independent Ventilation and Pressurization.
- B. Fire Protection Systems.
- C. Security Systems. D. Two-Way Communication System.
- E. Electrical Raceway for Fire Department Communication Systems. F. Electrical Raceway Serving Interior Exit Stairway and Terminating at a Steel Box Not
- Exceeding 16 Square Inches. 11. Provide a Portable Fire Extinguisher with a Minimum Rating of 1-A:10-B:C in Each Unit
- 12. 0.2 Occupant Load Factor at Stairways (CBC 1005.3.1 Stairways, Exception 1); 44" Minimum Width at Stairways (CBC 1011.2 Width and Capacity); 36" Minimum Width at Stairways for
- Occupant Load < 50. 13. 0.15" Occupant Load Factor at Other Egress Components (CBC 1005.3.2 Other Egress
- Components, Exception 1). 14. Walks, Pedestrian Ways, and Other Circulation Spaces Which are Part of the Required Egress System Shall Have a Minimum Clear Headroom as Required in Section 1003.2. Other Walks, Pedestrian Ways, and Circulation Spaces Shall Have a Minimum Clear Headroom of

Fire Rated Seperations

80 Inches.

_____ 1/2 Hour Fire Partition 1 Hour Fire Partition 2 Hour Fire Barrier 3 Hour Fire Barrier

Symbols Legend

Room Data

Room Name & Number Area Name 🚤 150 SF Net Room Area & Occupancy Classification Business - 1/100 Use & Load Factor 28 Occs - 2 Exits # of Occupants & Required Number of Exits Occupancy Load (actual) Occupants Per Room Travel Distance Path of Egress Illuminate with 1 Footcandle / Sf Min At The Floor Level Along Path, Typical Cumulative Occ. Load / Direction of Travel

Exiting Data

 Exit Discharge # Occs. Occupants 32 Inches Min. Exit Width Required

Area Designation

36 Inches Inches



Accessible Path of Egress Lighting with emergency power is required at the egress system. The egress path will be provided with egress lighting with backup power, providing 1 foot candle of light at floor level. The lighting level will be verified through a field test.

- Exit Width Provided

Fire Extinguisher, Location is Diagrammatic

Directional Exit Sign Per Electrical, Location is Diagrammatic (Design Build)

Note: See Door Schedule For Fire Rated Doors

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> Fernando **San** 12188 - 121

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PROJECT NO: 202203 DRAWN BY: Author CHECKED BY: Checker SCALE: As indicated

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ea Plans - Gross Square Footage

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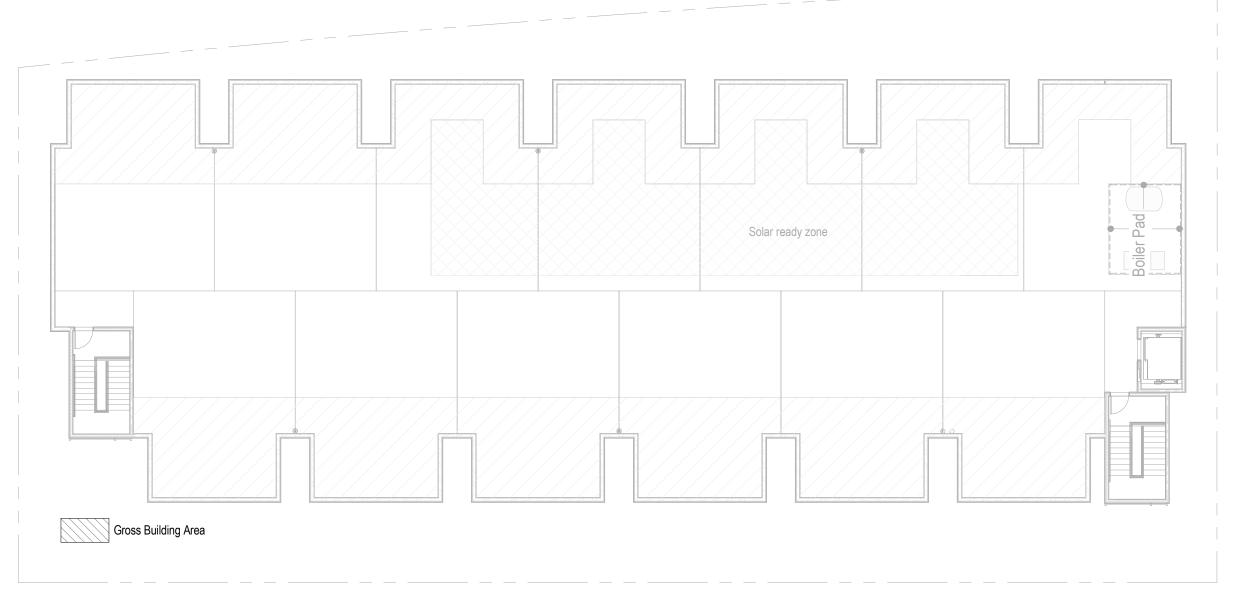
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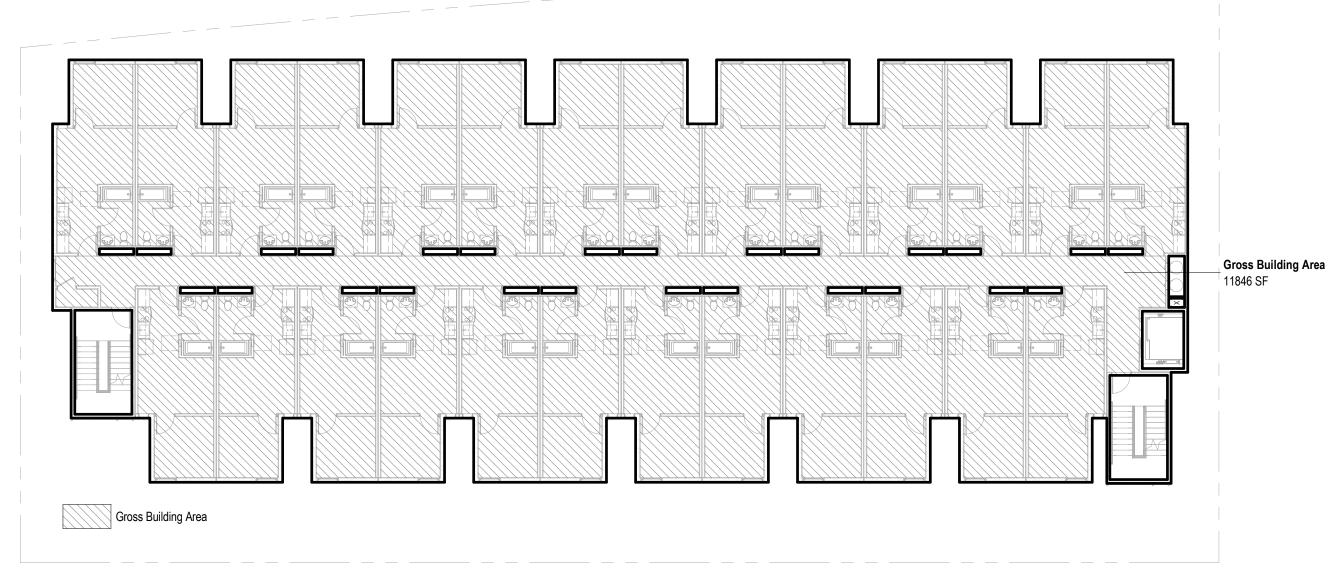
 SCALE :
 1/16" = 1'-0"

SHEET NO :

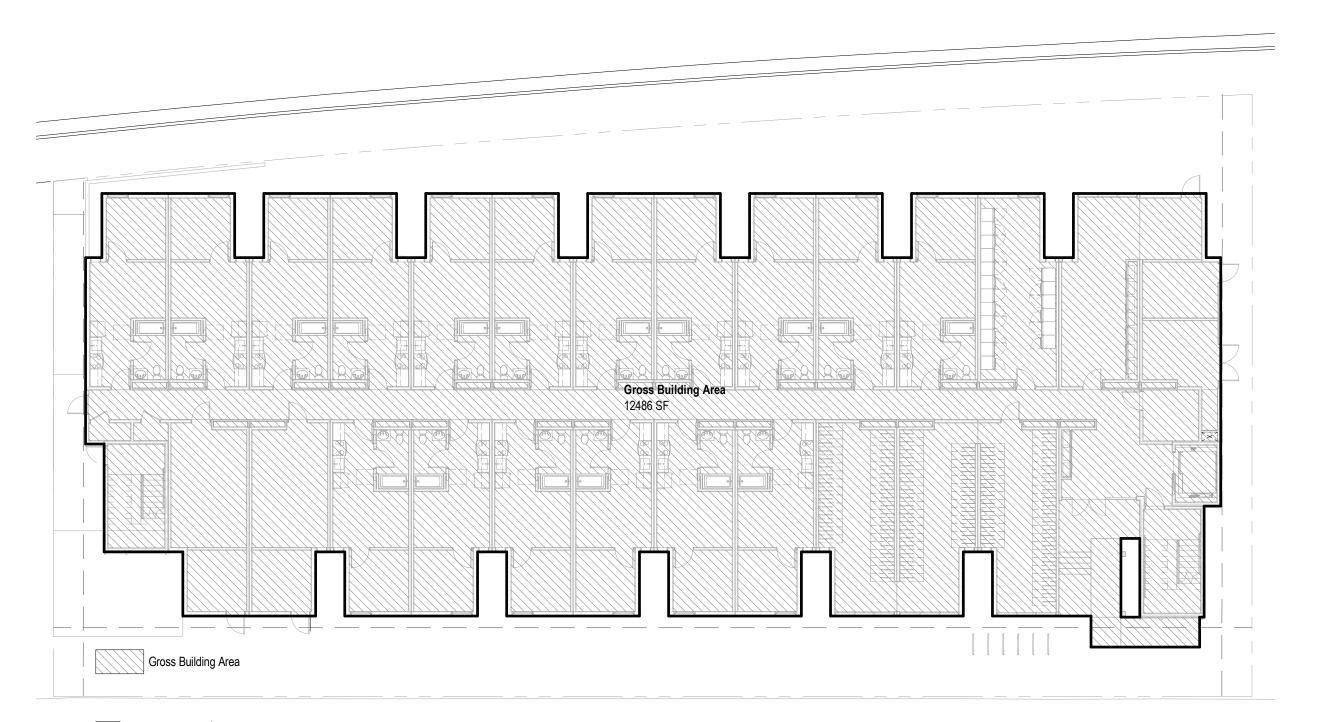
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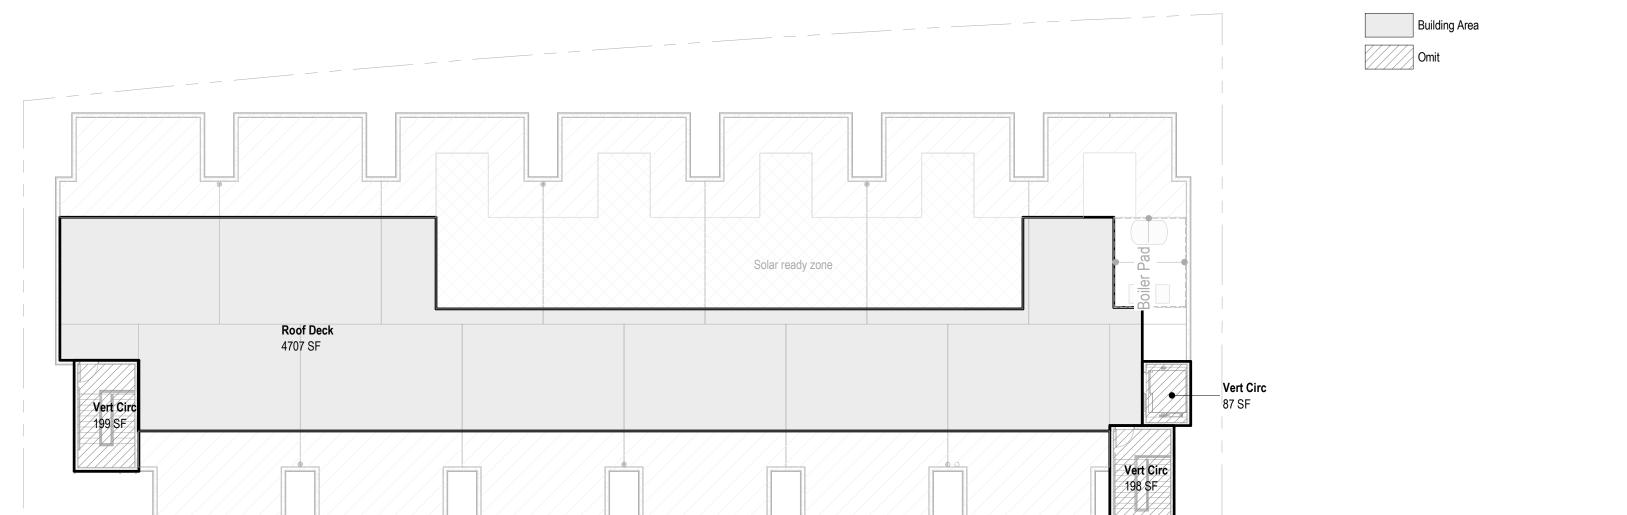


3 1/16" = 1'-0" Roof Level Gross Square Footage

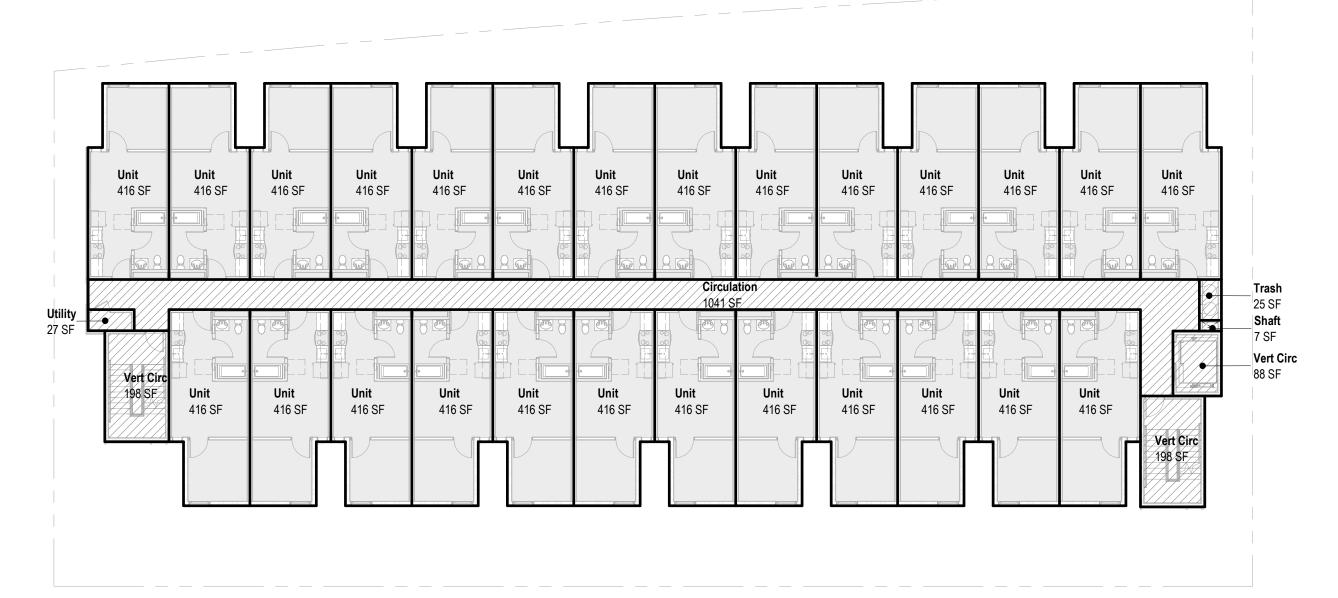


2 1/16" = 1'-0" **L02 - L05 Gross Square Footage**

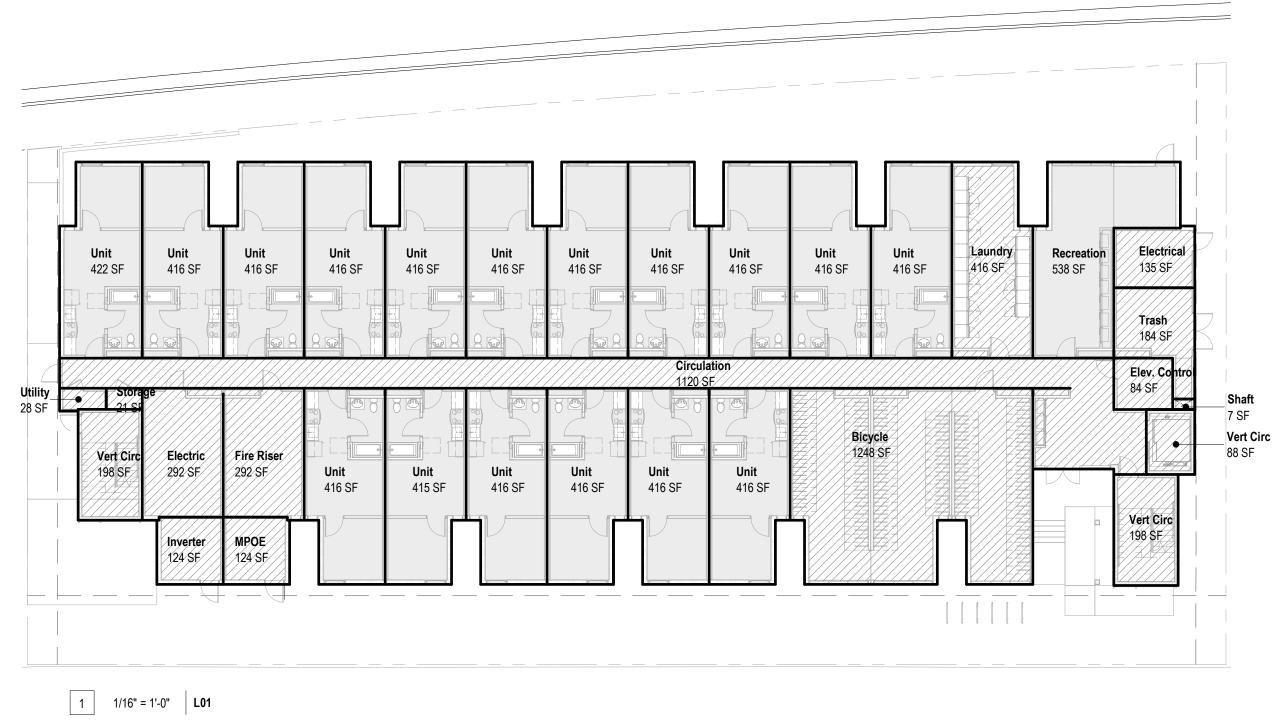




6 1/16" = 1'-0" **Roof**



2 1/16" = 1'-0" L02



Name	Count	Area
L01		
	1	1248 SF
Bicycle Circulation	1	1120 SF
Electric	1	292 SF
Electrical	1	135 SF
Elev. Control	1	84 SF
Fire Riser	1	292 SF
Inverter	1	124 SF
Laundry	1	416 SF
MPOE	1	124 SF
Shaft	1	7 SF
Storage	1	21 SF
Trash	1	184 SF
Utility	1	28 SF
Vert Circ	3	484 SF
		1
Recreation	1	538 SF
Unit	17	7078 SF
L01		12175 SF

uilding	Area Sche	dule	Building	g Area Sche	dule
ame	Count	Area	Name	Count	Are
			L05		
	1	1248 SF	Circulation	1	1041 SF
	1	1120 SF	Shaft	1	7 SF
	1	292 SF	Trash	1	25 SF
	1	135 SF	Utility	1	27 SF
rol	1	84 SF	Vert Circ	3	484 SF
	1	292 SF			-
	1	124 SF	Unit	26	10815 SI
	1	416 SF	L05		12399 SI
	1	124 SF			
	1	7 SF			
	1	21 SF			
	1	184 SF	Building	y Area Sche	dule
	1	28 SF			
	3	484 SF	Name	Count	Are
	1	538 SF	Roof		
	17	7078 SF	Roof Deck	1	4707 SF

484 SF 5191 SF

Count Area

66960 SF

Building Area Schedule

Grand Total SF

Name Count Area		
		1
L02		
Circulation	1	1041 SF
Shaft	1	7 SF
Trash	1	25 SF
Utility	1	27 SF
Vert Circ	3	484 SF
Unit	26	10815 SF
L02		12399 SF

Building Area

Building Area Schedule			
Name	Count	Area	
L03			
Circulation	1	1041 SF	
Shaft	1	7 SF	
Trash	1	25 SF	
Utility	1	27 SF	
Vert Circ	3	484 SF	
Unit	26	10815 SF	
L03		12399 SF	

Building Area Schedule			
Name	Count	Area	
L04			
Circulation	1	1041 SF	
Shaft	1	7 SF	
Trash	1	25 SF	
Utility	1	27 SF	
Vert Circ	3	484 SF	
	•		
Unit	26	10815 SF	
L04		12399 SF	

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Unit Mix Area Count Total Area Area Count Total Area Unit A Unit A-R 388 SF 3101 SF Unit A 388 SF 388 SF 388 SF 3489 SF Unit A-R 6591 SF

Unit Mix

Unit Mix

Unit Mix

Area Count Total Area

Area Count Total Area

5040 SF

5040 SF 10080 SF

5040 SF 5040 SF

10080 SF

46909 SF

Unit Type	Area	Count	Total Area	Unit Type
2				L05
it A	388 SF	13	5040 SF	Unit A
it A-R	388 SF	13	5040 SF	Unit A-R
2			10080 SF	L05

Unit Type	Area	Count	Total Area	Unit Type
3				Grand total SF
nit A	388 SF	13	5040 SF	
nit A-R	388 SF	13	5040 SF	
3			10080 SF	

Unit Mix Summary				
Unit Type	Area	Count	Total Area	
Unit A	388 SF	60	23261 SF	
Unit A-R	388 SF	61	23648 SF	
Total		121	46909 SF	

Unit Type	Count	
1-Bedroom	121	
Total:	121	
	·	
* "-R" Denotes "Reverse"		

Section 8 Unit Compliance	

Unit A-R (Typical 1 Bedroom in Project) See 2/G0.14

Unit A (Typical 1 Bedroom in Project)





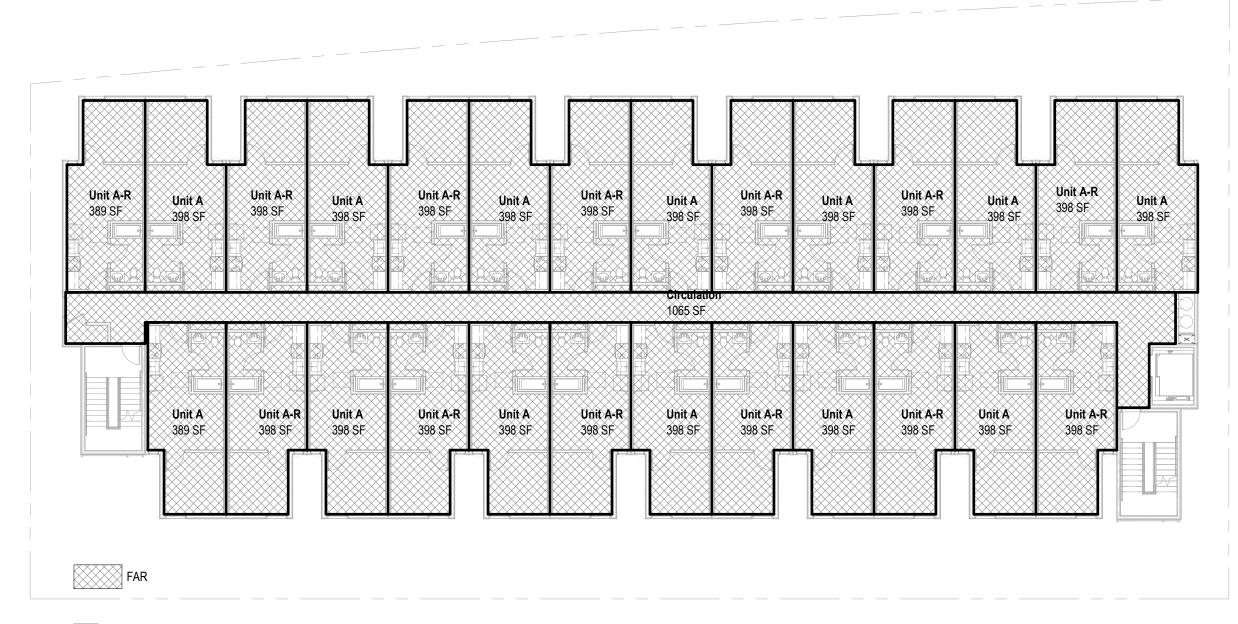
1 1/16" = 1'-0" **L01 Unit Mix**

3 1/16" = 1'-0" Roof Level Unit Mix

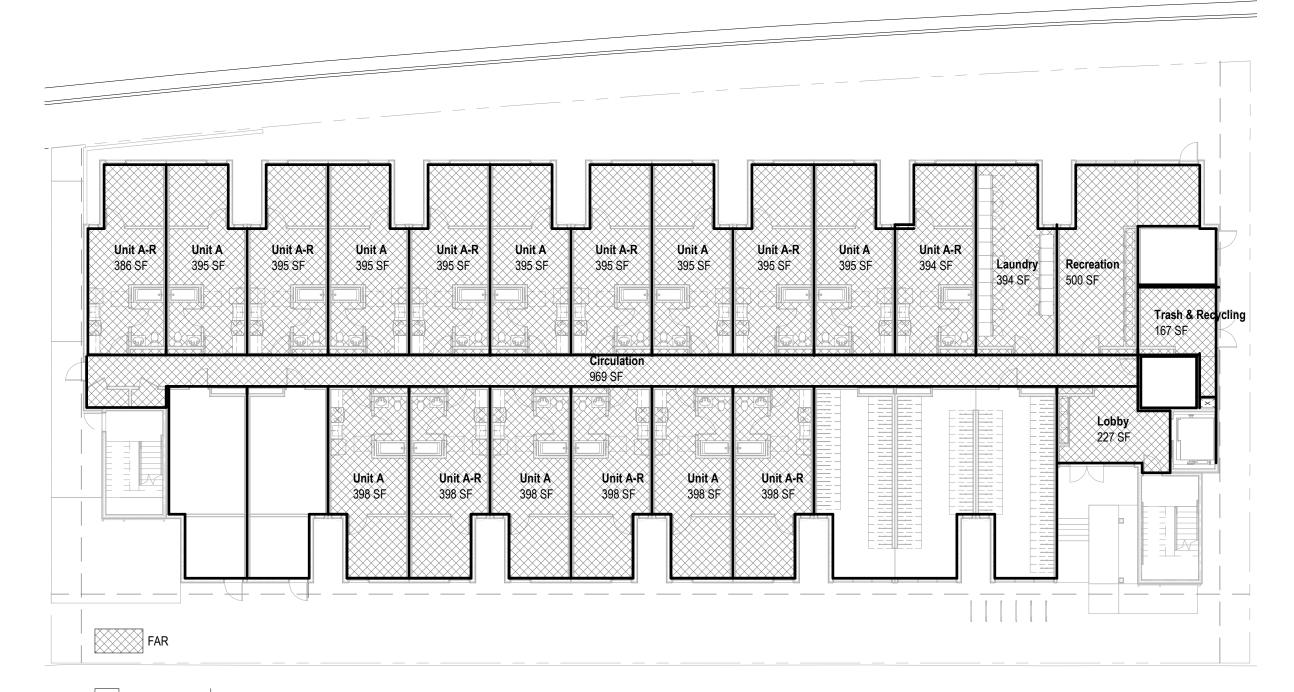
2 1/16" = 1'-0" **L02 - L05 Unit Mix**

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3 1/16" = 1'-0" Roof Level - FAR



2 1/16" = 1'-0" L02 - L05 Unit FAR



1 1/16" = 1'-0" **L01 Unit - FAR**

	Area Plans - FAR	
Name	Level	Area

L01		
Circulation	L01	969 SF
Laundry	L01	394 SF
Lobby	L01	227 SF
Recreation	L01	500 SF
Trash & Recycling	L01	167 SF
Unit A	L01	3169 SF
Unit A-R	L01	3554 SF
L01: 22		8980 SF

L02		
Circulation	L02	1065 SF
Unit A	L02	5169 SF
Unit A-R	L02	5169 SF
L02: 27		11402 SF

L03		
Circulation	L03	1065 SF
Unit A	L03	5169 SF
Unit A-R	L03	5169 SF
L03: 27		11402 SF

L04		
Circulation	L04	1065 SF
Unit A	L04	5169 SF
Unit A-R	L04	5169 SF
1 04: 27	•	11402 SF

.05		
Circulation	L05	1065 SF
Jnit A	L05	5169 SF
Jnit A-R	L05	5169 SF
.05: 27		11402 SF
Grand total		54590 SF

Allowable FAR per AB 2345: 4.05:1

Buildable Lot Area: 18,829 SF

Allowable FAR: 18,829 x 4.05 = **76,257 SF**

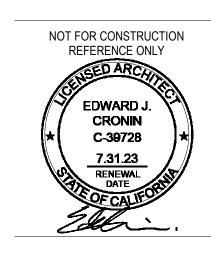
Proposed FAR: 54,590 SF (2.90:1)

LAMC 12.03. DEFINITIONS. FLOOR AREA. (Amended by Ord. No. 182,386, Eff. 3/13/13.) The area in square feet confined within the exterior walls of a Building, but not including the area of the following: exterior walls, stairways, shafts, rooms housing Building-operating equipment or machinery, parking areas with associated driveways and ramps, space dedicated to bicycle parking, space for the landing and storage of helicopters, and Basement storage areas.

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San Fernando 12188 - 12192 San Fernando Road Los Angeles, CA 91342



SET ISSUE :	
DATE :	ISSUE:
11.21.2022	PZA Submittal
12.15.2022	1st Plan check Submittal

PROJECT NO:	202203
DRAWN BY :	Author
CHECKED BY :	Checker
SCALE:	1/16" = 1'-0"

SHEET NO:

TRUE PLAN NORTH

G0.15

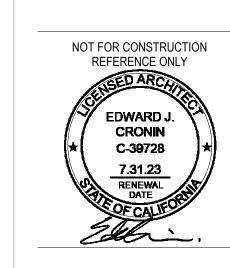
Open Space Required / Provided	Required	Provide
Allowable Open Space w/20% decreased in Open Space per AB 2345 Incentive	9,680SF	5,255 SF
Minimum Common Open Space w/AB 2345 Incentive	4,840 SF	5,255 SF
Required Landscaping	2,420 SF	2,420 SF
Required Trees	31	31

5255 SF

- A 100% Affordable AB 2345 Project with requests for Off-Menu Incentives and Waivers:
 Reduction of Side Set Back to 5 ft from 8 ft (LAMC)
 54.3% Reduction of Open Space Requirement (LAMC)
 19% Reduction of CPIO Glazing Requirement (LAMC)
 Waiver of One (1) Parking Space for every 20 Dwelling Units or Guest Rooms.
 Waiver of the CPIO Ground Floor Commercial Requirement for 75% of the Primary Frontage and Limitation of Dwelling Units on the Ground Level.

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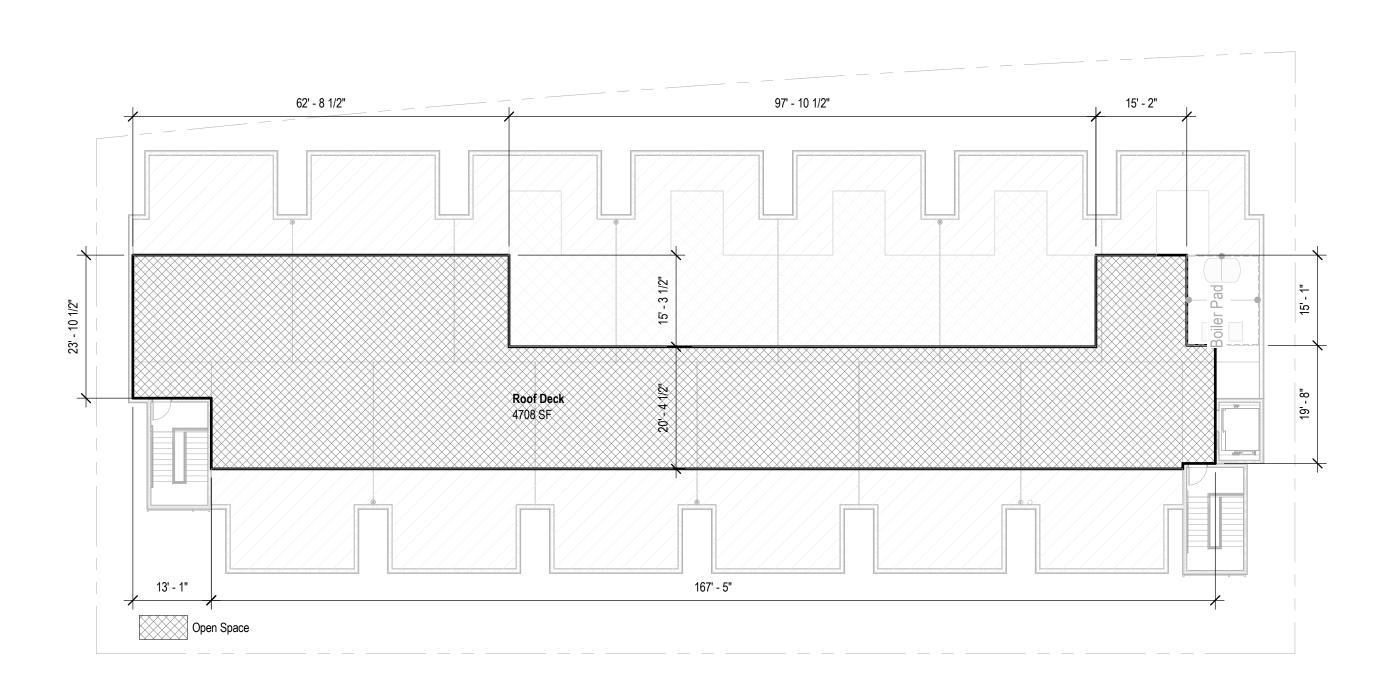


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DATE :	ISSUE:
11.21.2022	PZA Submittal
12.15.2022	1st Plan check Submitta

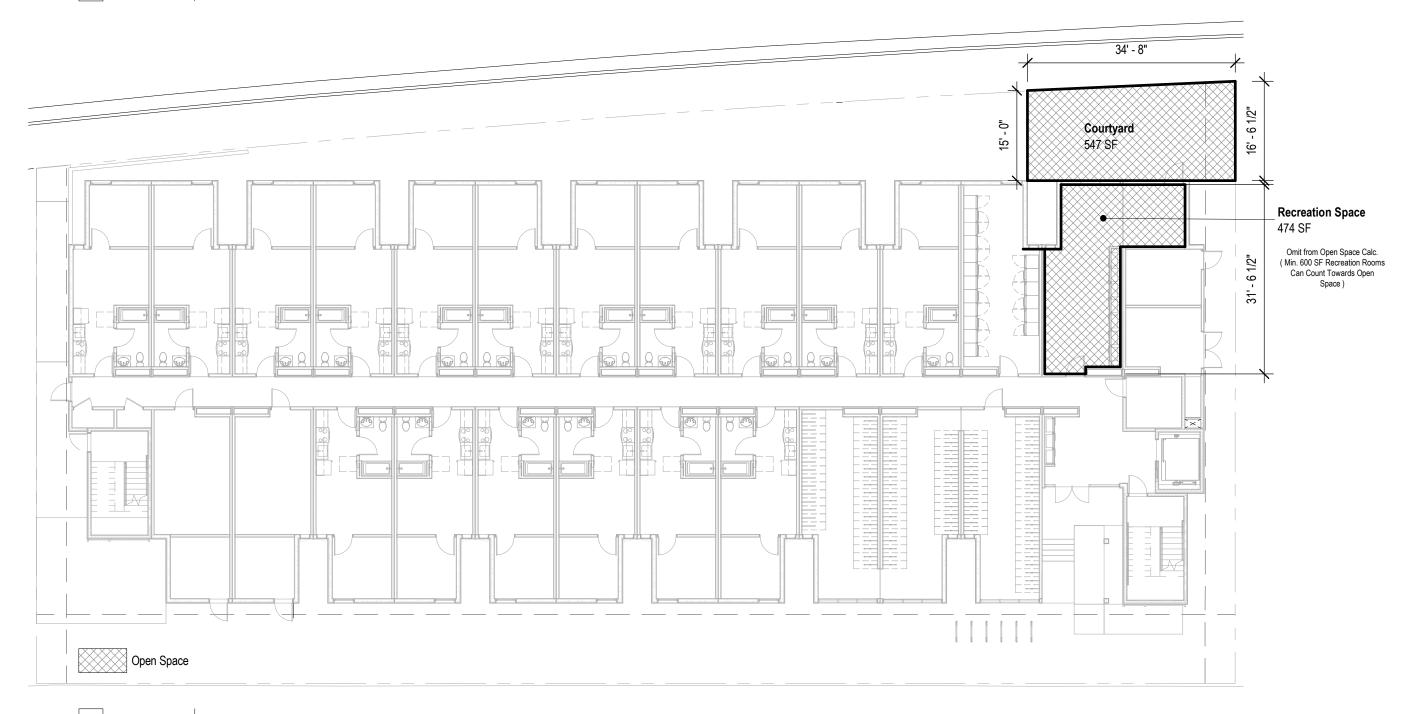
PROJECT NO :	202203
DRAWN BY :	Author
CHECKED BY:	Checker
SCALE :	1/16" = 1'-0"

SHEET NO:

G0.16



3 1/16" = 1'-0" Roof Level Open Space



1 1/16" = 1'-0" L01 Open Space

CPIO Requirements.

Building Design. In addition to any regulations set forth by the underlying zone and the LAMC, Projects with new construction or additions shall comply with the following building design regulations:

1. Per Table II - Ground Floor Commercial Use Limitation:

(a) Provide Cround Floor Commercial Use Alimitation:

(a) Provide Ground Floor Commercial uses along a Primary Frontage (San Fernando Road), at a min. Depth of 25 FT or the entire depth of the building, for a min. of 75% of the length of the Primary Frontage, excluding any area used for pedestrain and vehicular circulation.

pedestrain and venicular circulation.

(b) Units are limited to upper floors above non-residential uses, or behind non-residential uses that are at least 25 FT in depth.

2. **Articulation.** All exterior building walls shall provide a break in the plane, or a change in material, at least every 25 FT horizontal of building facadefacing a street, a building shall incoporate at least one item from three of the four following categories:

- Category 1: Columns, Pilaster, posts, or trellises

Category 2: Wall recessed, projections, or offset
Category 3: Arcades, awnings, or canopies
Category 4: Windows or Storefront Bay

3. **Glazing:** The Primary Frontage of any building that has non-residential uses on the ground floor shall consist of at least 50% transparent doors and windows.

4. **Building Elevations & Facade:** Building entrance and/or Windows shall includes at least one item from three of the four following categories:

- Category 1: Projections or recessed entrances and windows with a minimum four inches recessed

Category 2: Decorative pedestrain lightingCategory 3: Courtards, entry ways, or landing porches

- Category 4: Planter Boxes, window sills, shutters, canopies, or awnings

Decorative screen wall, a trellis with climbing vines or plant materials, a landscped planting bed, or other continuous architectural element shall be installed on all blank walls facing a street or parking lot

5. Entrances & Pedestrain Circulation:

A Prominent ground or first floor entry shall be created such as a lobby or atrium, along the primary frontage
 Pedestrain pathways leading directly fromt he public sidewalk to the primary building entracnes, pedestrain amenity spaces, and parking areas shall be provided. A change in grade, materials, textures, colors, or landscaping to improve pedestrian visibility and safety shall be used.

- Ancillary lingitng shall be provided along pedestrain and vehicular access ways. All outdoor lighting and direct lighting shall be shielded onto the pathway.

6. Parking and Vehiculat Circulation (Design):

New surface parking shall be located at the rear or side of buildings and/ or provide a semi-subterranean or subterranean grade.
 Side streets or alleys are the primary point of vehicular access to off-street parking, loading areas, and trash enclosures, unless determined infeasible by the department of transportation

Architectural openings, and use varied building materials, decorative screening, climbing vines, or green walls.
On site surface parking which abuts a sidewalk and/ or street, a max. 42 inches in height hedge or landscaped wall or fence shall be installed within five feet of the entire length of the street

7. **Open Space:**

- For every 100 SF of non-residential floor area, one sq.ft. of open space shall be provided. The min. Open Space area is 200 SF, with max. of 5,000 sf of open space required for the project site.

- Open Space shall be visible and accessible from the Primary Frontage side walk and include pedestrain amenities, such as benches, landscaping, water features, and tables.

8. Yard, Parkways

- Improved with landscaping that seperates the curb from the sidewalk with native and / or drought tolerant species, low-growing vegetation, or permeable materials, and shade street trees. Threes shall be planted along parkways to the statisfaction of the Urban Forestry Division Bureau of Street Service.

- Native and /or drought tolerant plant species shall be used and installed with an automatic irrigation system or comparable watering system on all landscape areas.

9. Equipment & Utilities:

- Air conditioning units, antennas, communication equipemnt, mechanical and vents shall be screened from street view. Equipment located min. 5FT from a roof edge.

All exterior mechanical equipment, utilites, storage and trash bins shall be enclosed or screened with materials that are similar to those used in the primary structure.
Utilites, gas, electrical and water meter to place in side yard, set backs or in landscaped areas that are out of the line-of-sight

from crosswalks or sidewalk

- Utilities on roof top shall be concealed by a parapet.

CPIO Glazing / Transparent Area Table

Total Glazing / Transparent Area of Windows/Doors

(The Primary Frontage of Any Building that has Non-Residential Uses on the Ground Floor Shall Consist of at least 50% Transparent Doors and Window)

	Primary Frontage Area	Clear Transparent Glazing Area	Glazing Percentage Proposed	Required Glazing Percentage
Building Facade (Ground Floor)	1,771 SF	551 SF	31%	50%

A 100% Affordable AB 2345 Density Bonus Project with requests for Off-Menu Incentives and Waivers:

- 54.3% Reduction of Open Space Requirement (LAMC)
 19% Reduction of CPIO Glazing Requirement (LAMC)
- Waiver of One (1) Parking Space for every 20 Dwelling Units or Guest Rooms.
 Waiver of the CPIO Ground Floor Commercial Requirement for 75% of the Primary Frontage
- and Limitation of Dwelling Units on the Ground Level.

	2' - 5"	22' - 2"	4' - 10"	22' - 2"	4' - 10"	22' - 2"	4' - 10"	22' - 2"	4' - 10"	22' - 2"	4' - 10"	22' - 2"	<u> </u>	15' - 11"	5' - 0"	
ack													Elevator Control	Elevator	Set Back	
tback				 Massing Changing to Provide Art in Horizontal Length per CPIO; C 	ticulation Chapter V:								Room		tback	
<u> </u>	- + +			Section V-2. C.4.(b)			_								Set ————————————————————————————————————	T.O. Elevator F
				Provide Articulation in Vertical Le CPIO; Chapter V: Section V-2. C	ength per c.4.(b)								↓			T.O. Stair
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1 1" = 10'-0" South Elevation - CPIO Glazing

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OF CALIFORNIA

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 DATE :
 ISSUE :

 11.21.2022
 PZA Submittal

 12.15.2022
 1st Plan check Submittal

PROJECT NO: 202203

DRAWN BY: Author

SHEET NO:

G0.22

CHECKED BY: Checker

SCALE: As indicated

General Notes

pedestrain and vehicular circulation.

transparent doors and windows.

following categories:

safety shall be used.

7. Open Space:

shielded onto the pathway.

additions shall comply with the following building design regulations:

1. Per Table II - Ground Floor Commercial Use Limitation:

- Category 1: Columns, Pilaster, posts, or trellises - Category 2: Wall recessed, projections, or offset

- Category 3: Arcades, awnings, or canopies

- Category 4: Windows or Storefront Bay

- Category 2: Decorative pedestrain lighting

5. Entrances & Pedestrain Circulation:

6. Parking and Vehiculat Circulation (Design):

benches, landscaping, water features, and tables.

Urban Forestry Division Bureau of Street Service.

- Utilities on roof top shall be concealed by a parapet.

watering system on all landscape areas.

located min. 5FT from a roof edge.

those used in the primary structure.

from crosswalks or sidewalk

9. Equipment & Utilities:

determined infeasible by the department of transportation

be installed within five feet of the entire length of the street

with max. of 5,000 sf of open space required for the project site.

- Category 3: Courtards, entry ways, or landing porches

element shall be installed on all blank walls facing a street or parking lot

- Category 4: Planter Boxes, window sills, shutters, canopies, or awnings

Building Design. In addition to any regulations set forth by the underlying zone and the LAMC, Projects with new construction or

or the entire depth of the building, for a min. of 75% of the length of the Primary Frontage, excluding any area used for

2. **Articulation.** All exterior building walls shall provide a break in the plane, or a change in material, at least every 25 FT

horizontal of building facadefacing a street, a building shall incoporate at least one item from three of the four following categories:

3. **Glazing:** The Primary Frontage of any building that has non-residential uses on the ground floor shall consist of at least 50%

4. Building Elevations & Facade: Building entrance and/or Windows shall includes at least one item from three of the four

Decorative screen wall, a trellis with climbing vines or plant materials, a landscped planting bed, or other continuous architectural

- Pedestrain pathways leading directly fromt he public sidewalk to the primary building entracnes, pedestrain amenity spaces, and parking areas shall be provided. A change in grade, materials, textures, colors, or landscaping to improve pedestrian visibility and

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- New surface parking shall be located at the rear or side of buildings and/ or provide a semi-subterranean or subterranean grade. - Side streets or alleys are the primary point of vehicular access to off-street parking, loading areas, and trash enclosures, unless

- On site surface parking which abuts a sidewalk and/ or street, a max. 42 inches in height hedge or landscaped wall or fence shall

- For every 100 SF of non-residential floor area, one sq.ft. of open space shall be provided. The min. Open Space area is 200 SF,

- Improved with landscaping that seperates the curb from the sidewalk with native and / or drought tolerant species, low-growing vegetation, or permeable materials, and shade street trees. Threes shall be planted along parkways to the statisfaction of the

- Air conditioning units, antennas, communication equipemnt, mechanical and vents shall be screened from street view. Equipment

- All exterior mechanical equipment, utilites, storage and trash bins shall be enclosed or screened with materials that are similar to

- Utilites, gas, electrical and water meter to place in side yard, set backs or in landscaped areas that are out of the line-of-sight

- Native and /or drought tolerant plant species shall be used and installed with an automatic irrigation system or comparable

- Open Space shall be visible and accessible from the Primary Frontage side walk and include pedestrain amenities, such as

- Category 1: Projections or recessed entrances and windows with a minimum four inches recessed

- A Prominent ground or first floor entry shall be created such as a lobby or atrium, along the primary frontage

- Architectural openings, and use varied building materials, decorative screening, climbing vines, or green walls.

(b) Units are limited to upper floors above non-residential uses, or behind non-residential uses

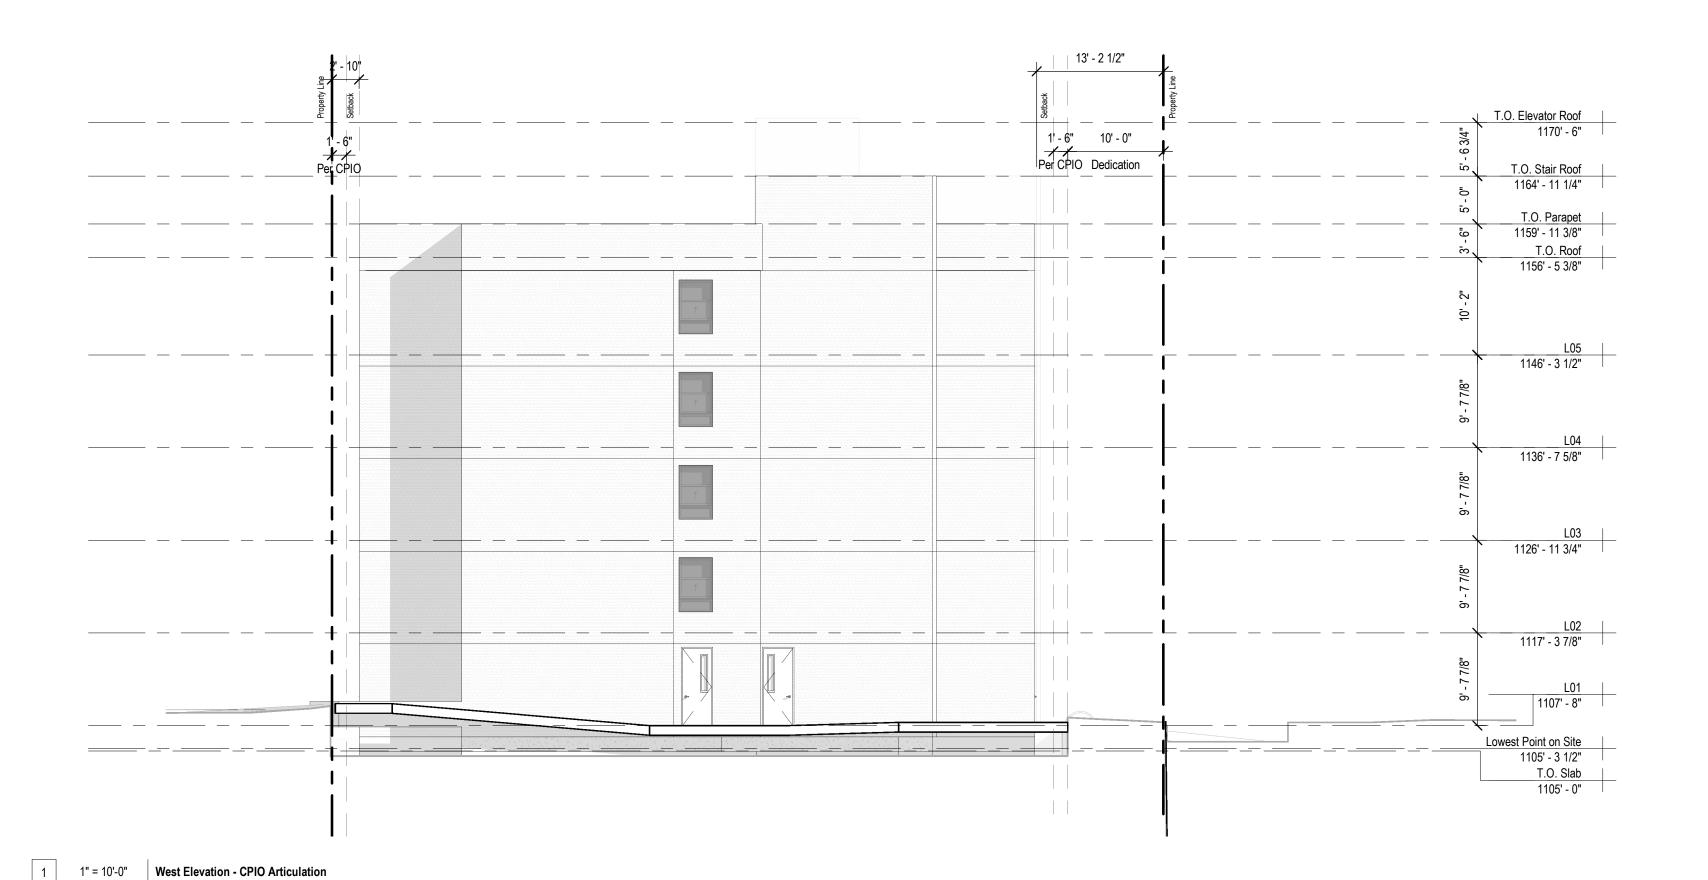
(a) Provide Ground Floor Commercial uses along a Primary Frontage (San Fernando Road), at a min. Depth of 25 FT

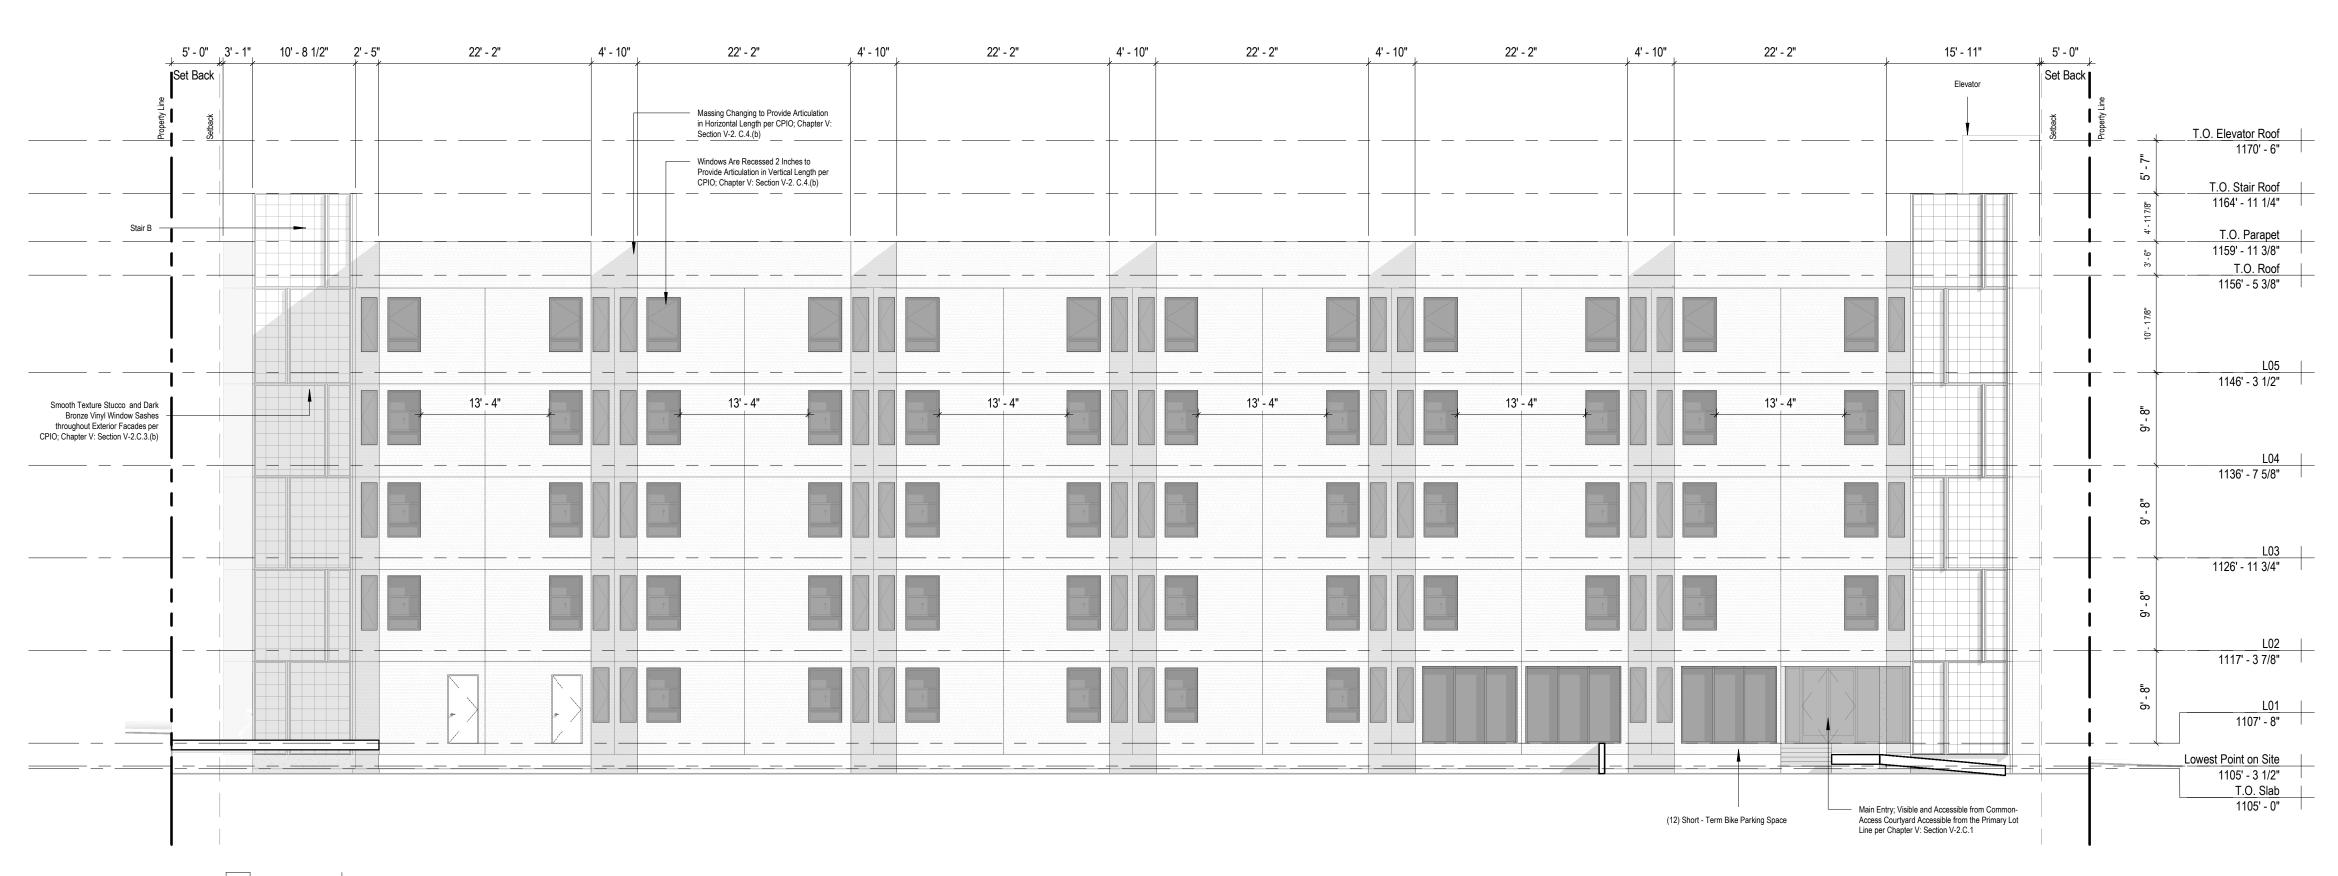
that are at least 25

CPIO Requirements.

FT in depth.

PROJECT NO: 202203 DRAWN BY: Author CHECKED BY: Checker SCALE: As indicated





2 1" = 10'-0" South Elevation - CPIO Articulation

San Fernando 12188 - 12192 San Fernando Road Los Angeles, CA 91342

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As indicated

SHEET NO:

SCALE:

30' - 7 1/2" T.O. Elevator Roof 10' - 0" 1' - 6" Dedication Per CPIO 1164' - 11 1/4" 1159' - 11 3/8" L05 1146' - 3 1/2" L03 1126' - 11 3/4" L02 1117' - 3 7/8" 1107' - 8" 1105' - 3 1/2" T.O. Slab 1105' - 0"

2 1" = 10'-0" East Elevation - CPIO Articulation

5' - 0" 22' - 2" 22' - 2" 22' - 2" 22' - 2" 22' - 2" 2' - 8 1/2" Lowest Point on Site T.O. Slab

1 1" = 10'-0" North Elevation - Exterior Elevation

General Notes

CPIO Requirements.

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8. Yard, Parkways:

- Improved with landscaping that seperates the curb from the sidewalk with native and / or drought tolerant species, low-growing vegetation, or permeable materials, and shade street trees. Threes shall be planted along parkways to the statisfaction of the Urban Forestry Division Bureau of Street Service.

- Native and /or drought tolerant plant species shall be used and installed with an automatic irrigation system or comparable watering system on all landscape areas.

9. Equipment & Utilities:

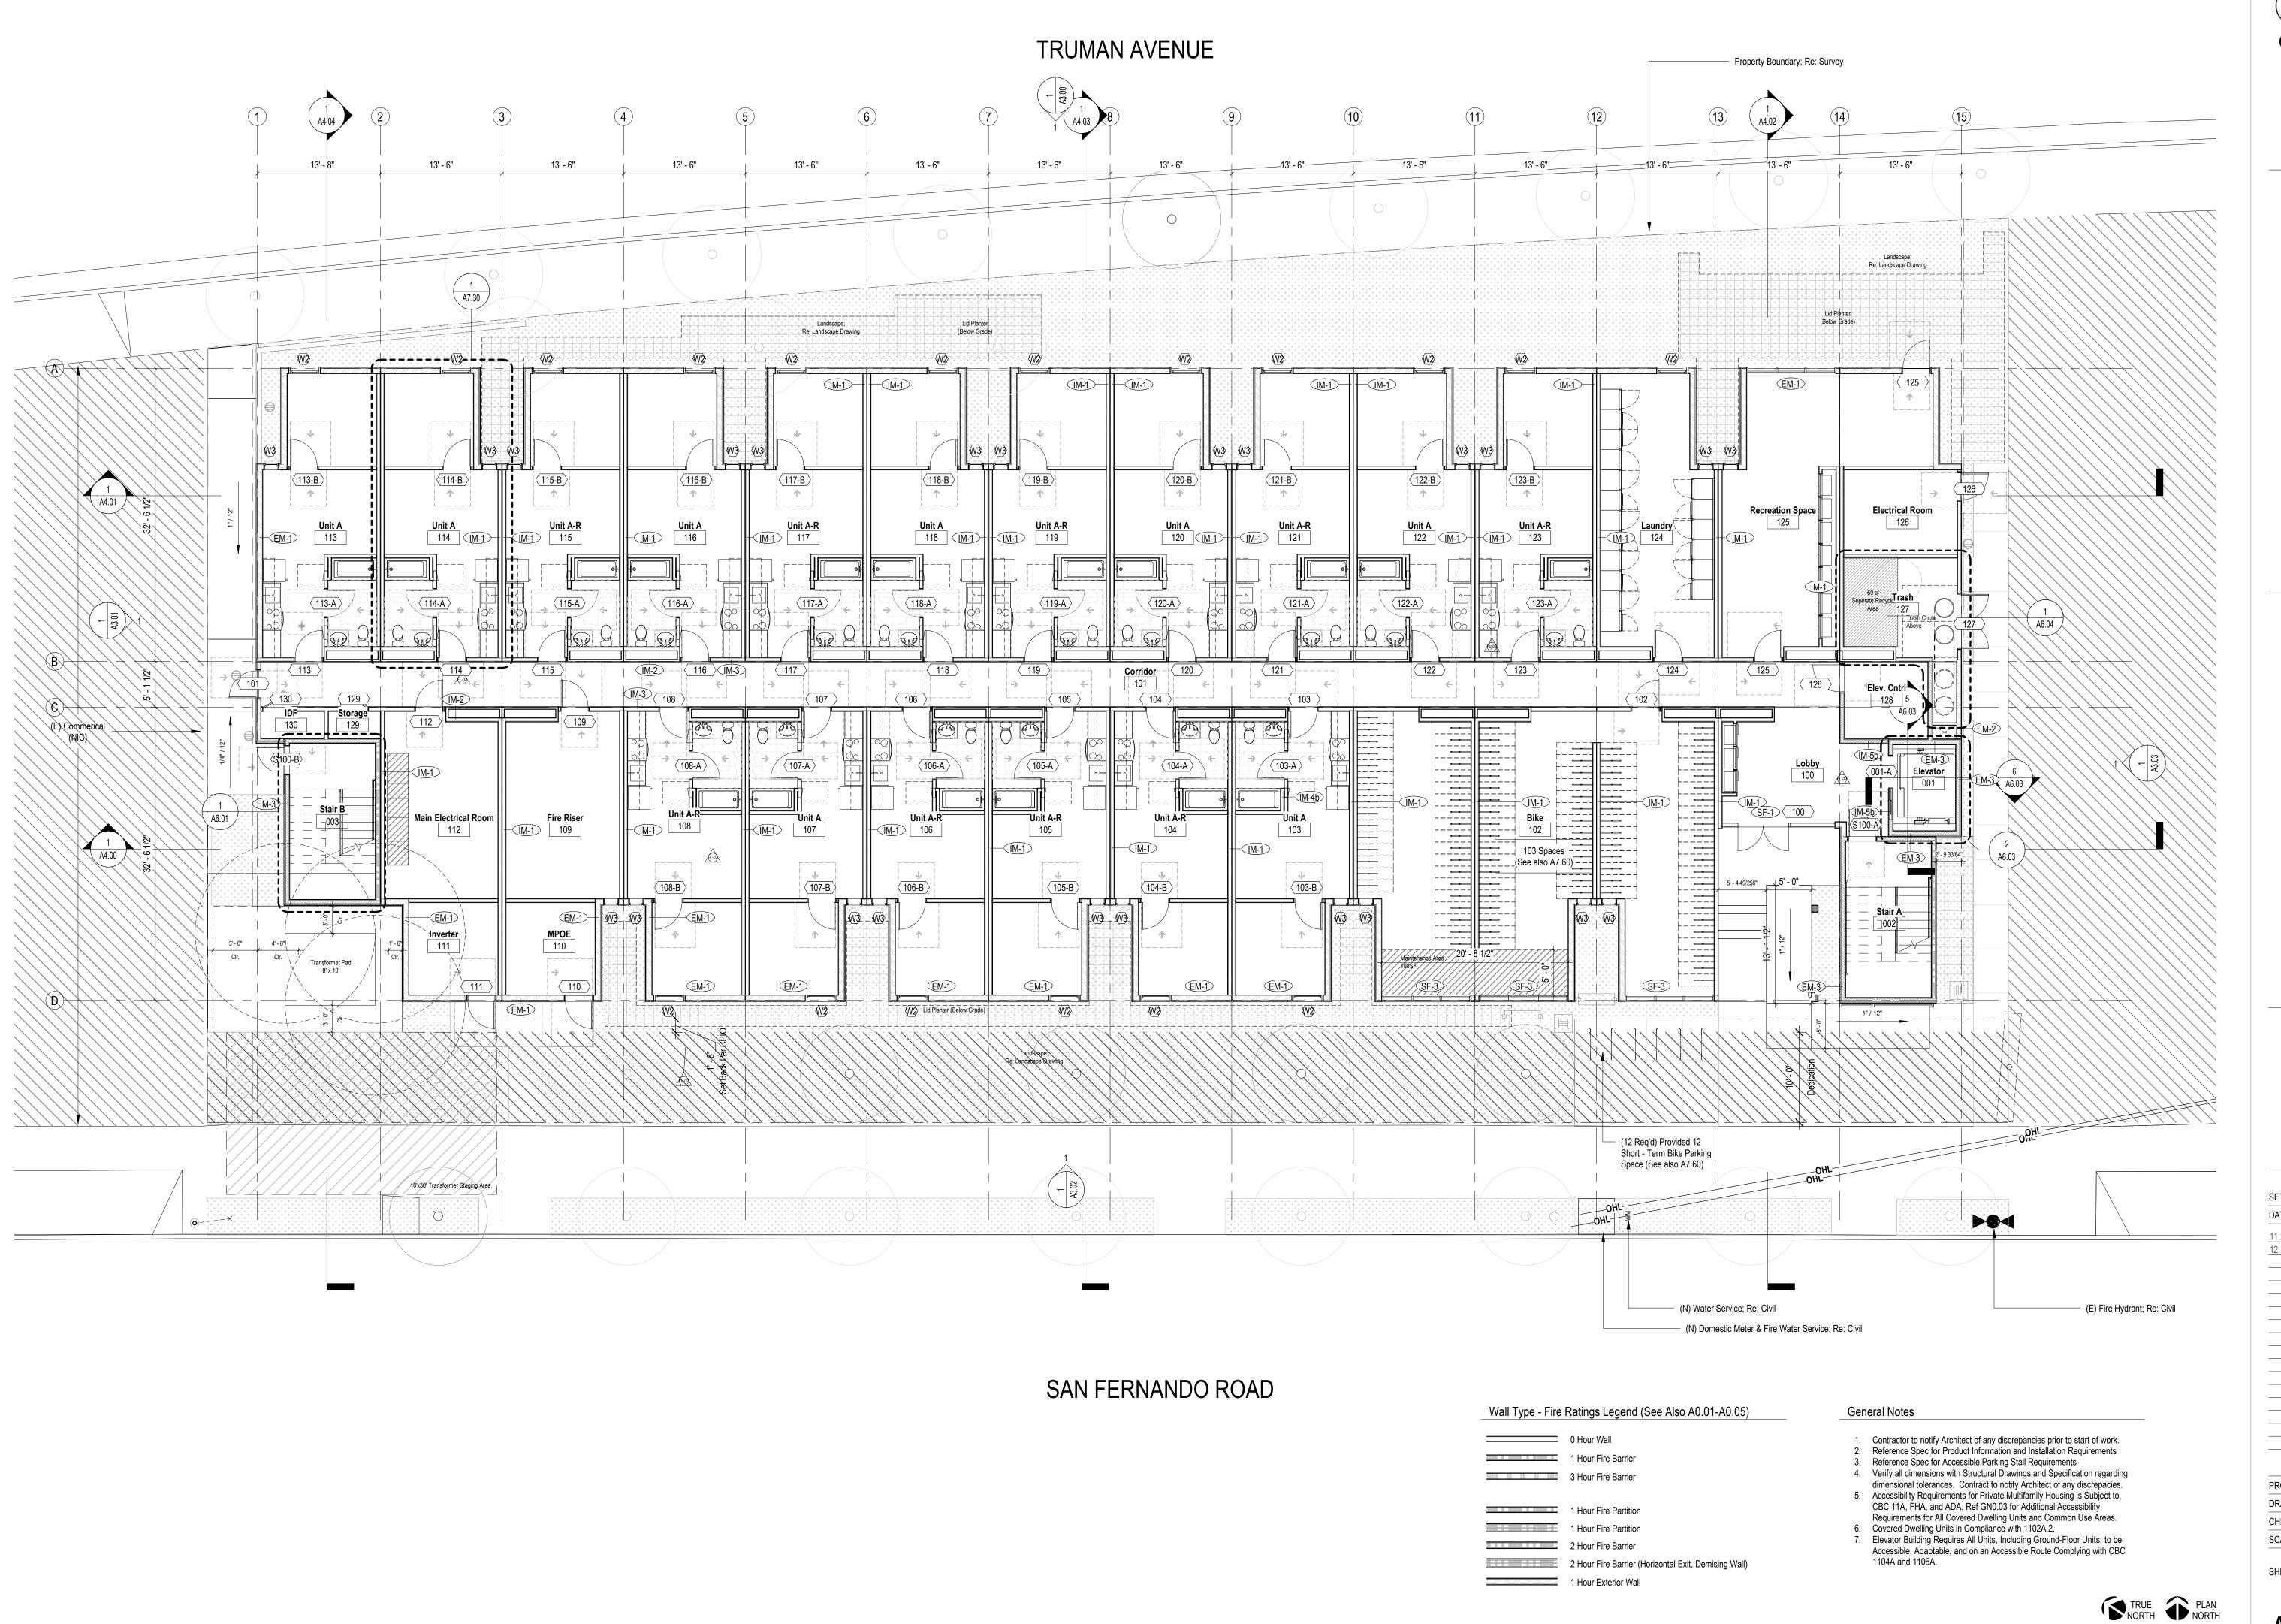
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- Utilites, gas, electrical and water meter to place in side yard, set backs or in landscaped areas that are out of the line-of-sight

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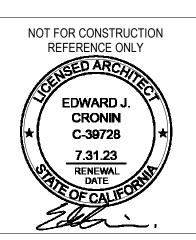
1105' - 0"



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verall Floor Plans - L01



SET ISSUE :

DATE : ISSUE :

11.21.2022 PZA Submittal

12.15.2022 1st Plan check Submittal

PROJECT NO: 202203

DRAWN BY: Author

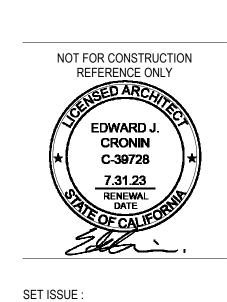
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SCALE: As indicated

SHEET NO:

A2.00

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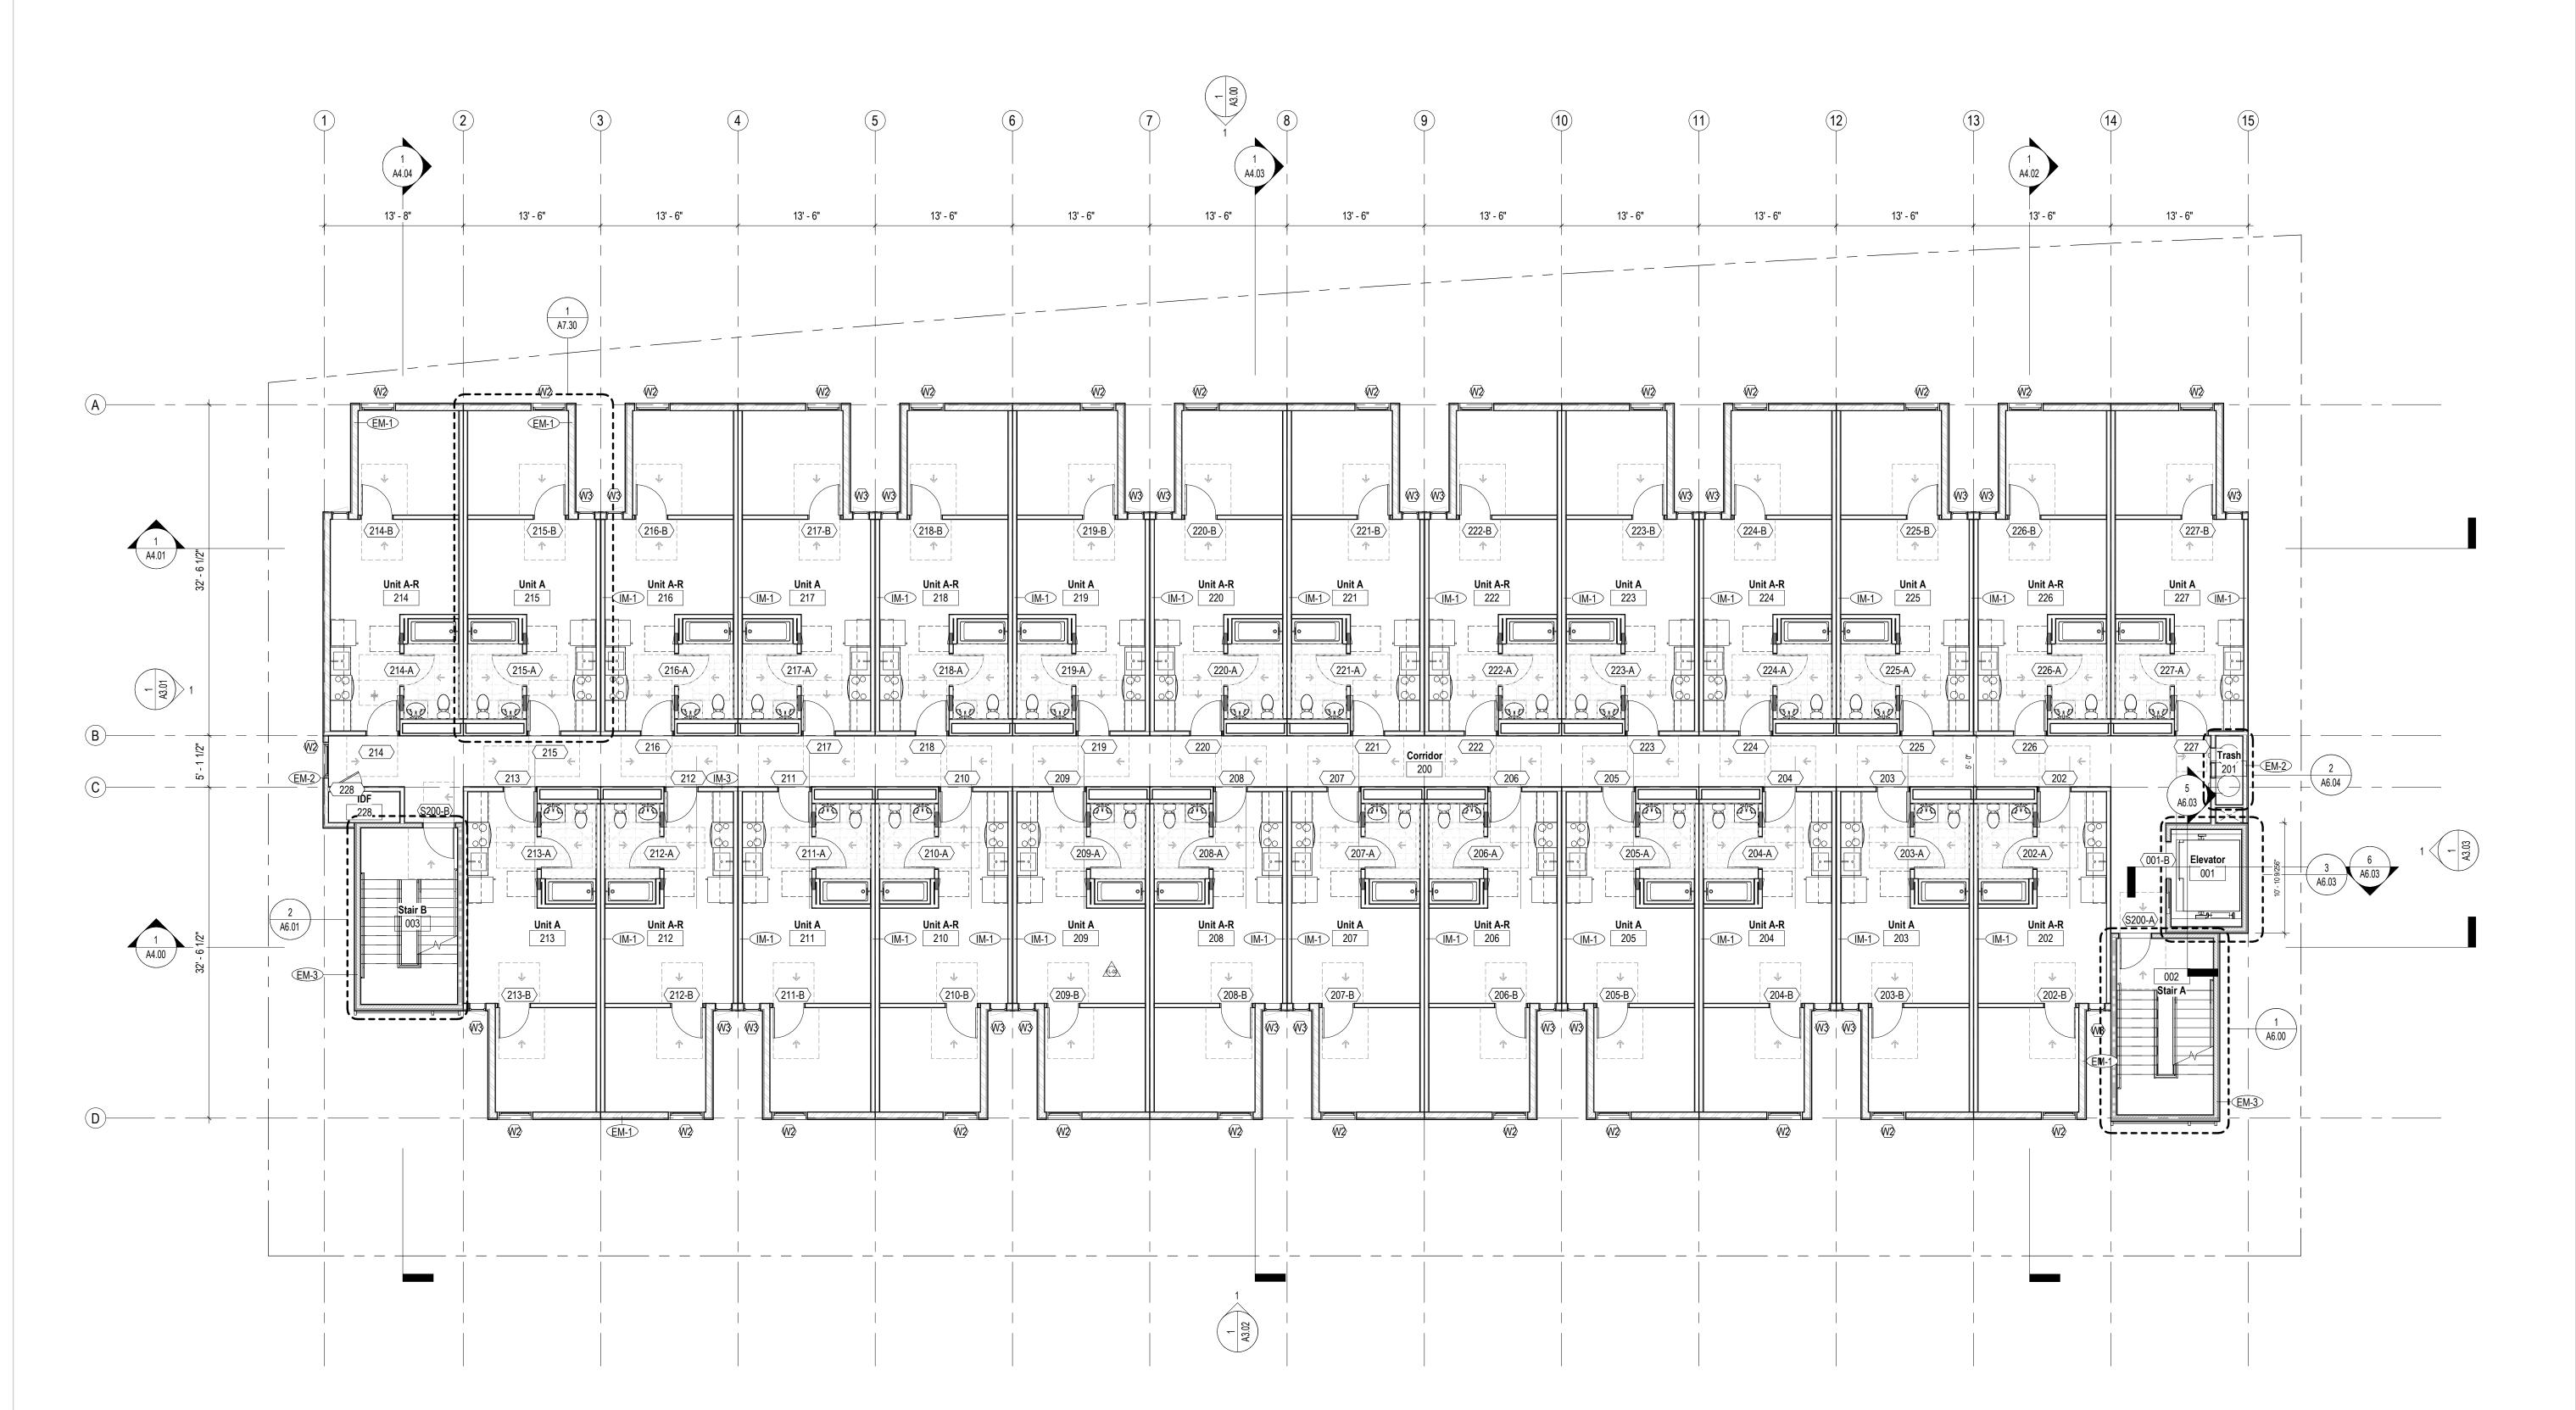


DATE: 11.21.2022 PZA Submittal 12.15.2022 1st Plan check Submittal

PROJECT NO: 202203 DRAWN BY: Author CHECKED BY: Checker SCALE: As indicated

SHEET NO:

TRUE PLAN NORTH



<i>y</i> 1	5 5 1	,
	0 Hour Wall	
	1 Hour Fire Barrier	
	3 Hour Fire Barrier	
	1 Hour Circ Doublion	

General Notes

1. Contractor to notify Architect of any discrepancies prior to start of work. Reference Spec for Product Information and Installation Requirements

4. Verify all dimensions with Structural Drawings and Specification regarding dimensional tolerances. Contract to notify Architect of any discrepacies.

5. Accessibility Requirements for Private Multifamily Housing is Subject to

CBC 11A, FHA, and ADA. Ref GN0.03 for Additional Accessibility

7. Elevator Building Requires All Units, Including Ground-Floor Units, to be

Requirements for All Covered Dwelling Units and Common Use Areas.

Accessible, Adaptable, and on an Accessible Route Complying with CBC

3. Reference Spec for Accessible Parking Stall Requirements

6. Covered Dwelling Units in Compliance with 1102A.2.

1104A and 1106A.

Wall Type - Fire Ratings Legend (See Also A0.01-A0.05)

1 Hour Fire Partition 1 Hour Fire Partition

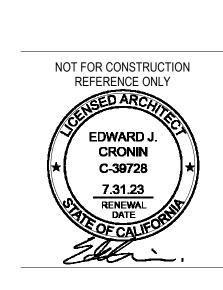
2 Hour Fire Barrier

1 Hour Exterior Wall

2 Hour Fire Barrier (Horizontal Exit, Demising Wall)

1 1/8" = 1'-0" **L02**

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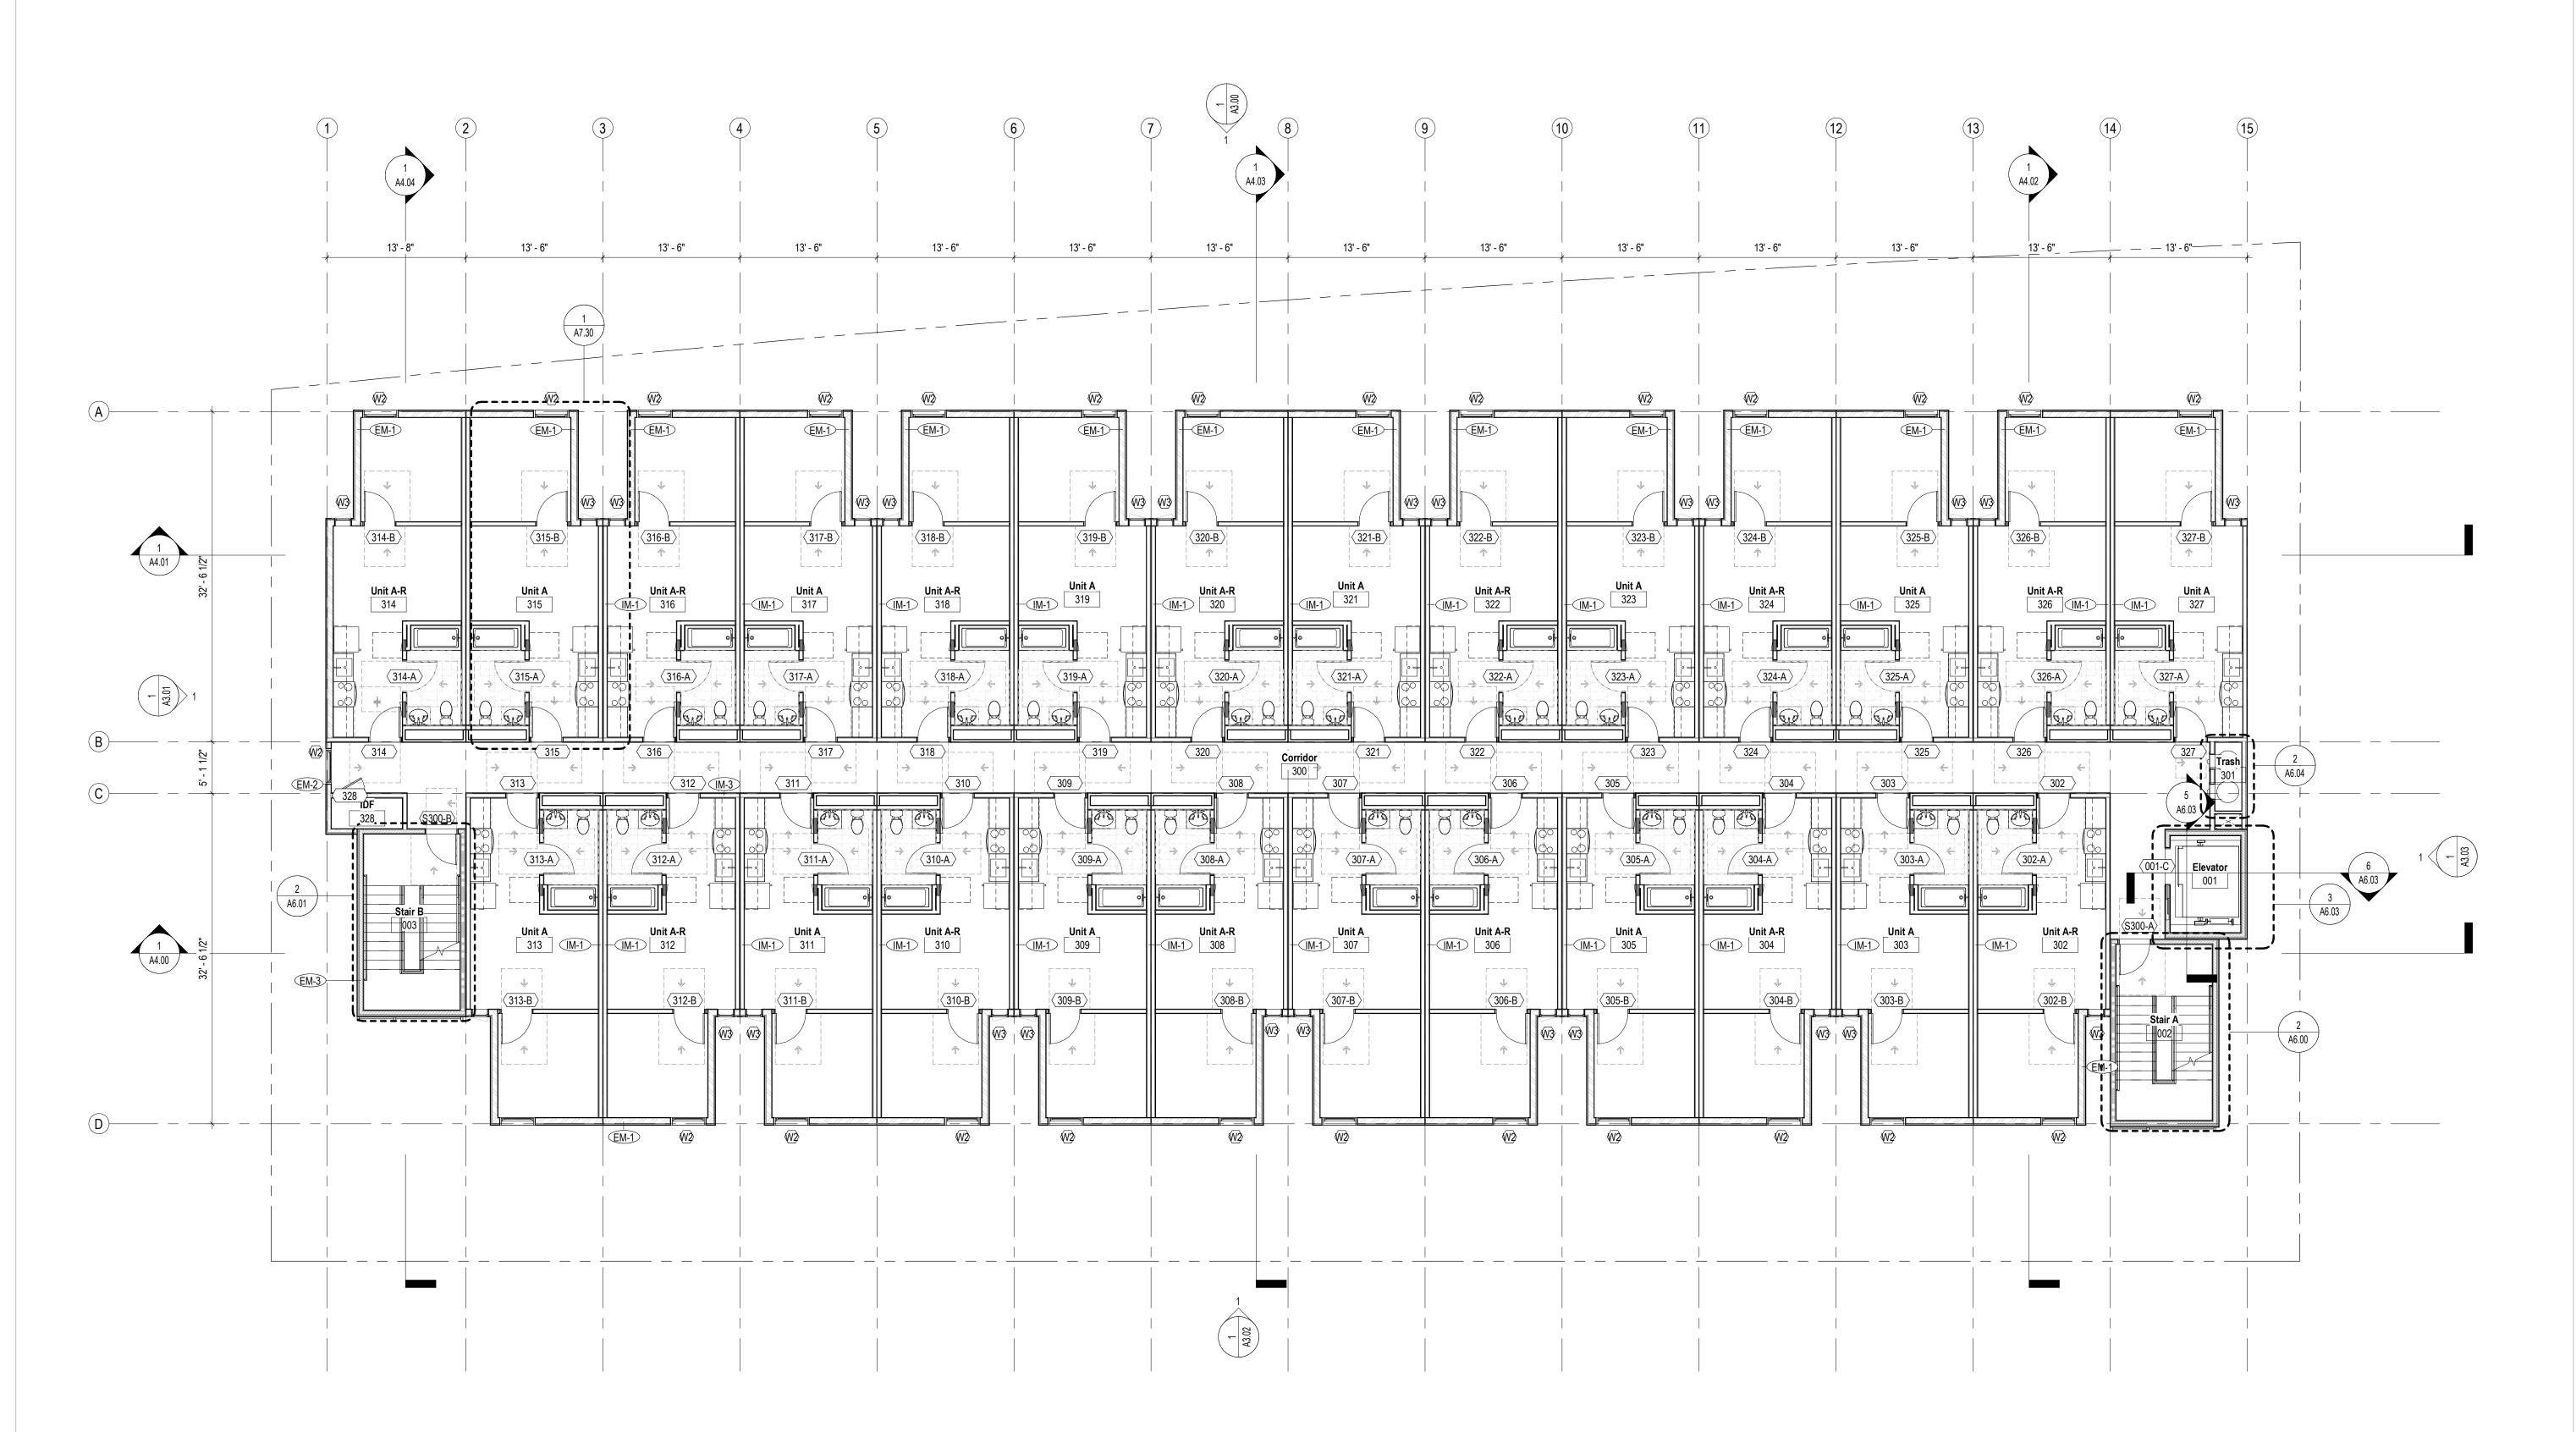
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PROJECT NO: 202203 DRAWN BY: Author CHECKED BY: Checker SCALE: As indicated

SHEET NO:



Wall Type - Fire Ratings Legend (See Also A0.01-A0.05)

General Notes

Contractor to notify Architect of any discrepancies prior to start of work.
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Requirements for All Covered Dwelling Units and Common Use Areas.

Accessible, Adaptable, and on an Accessible Route Complying with CBC

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Reference Spec for Accessible Parking Stall Requirements 4. Verify all dimensions with Structural Drawings and Specification regarding

6. Covered Dwelling Units in Compliance with 1102A.2.

1104A and 1106A.

0 Hour Wall 1 Hour Fire Barrier 3 Hour Fire Barrier

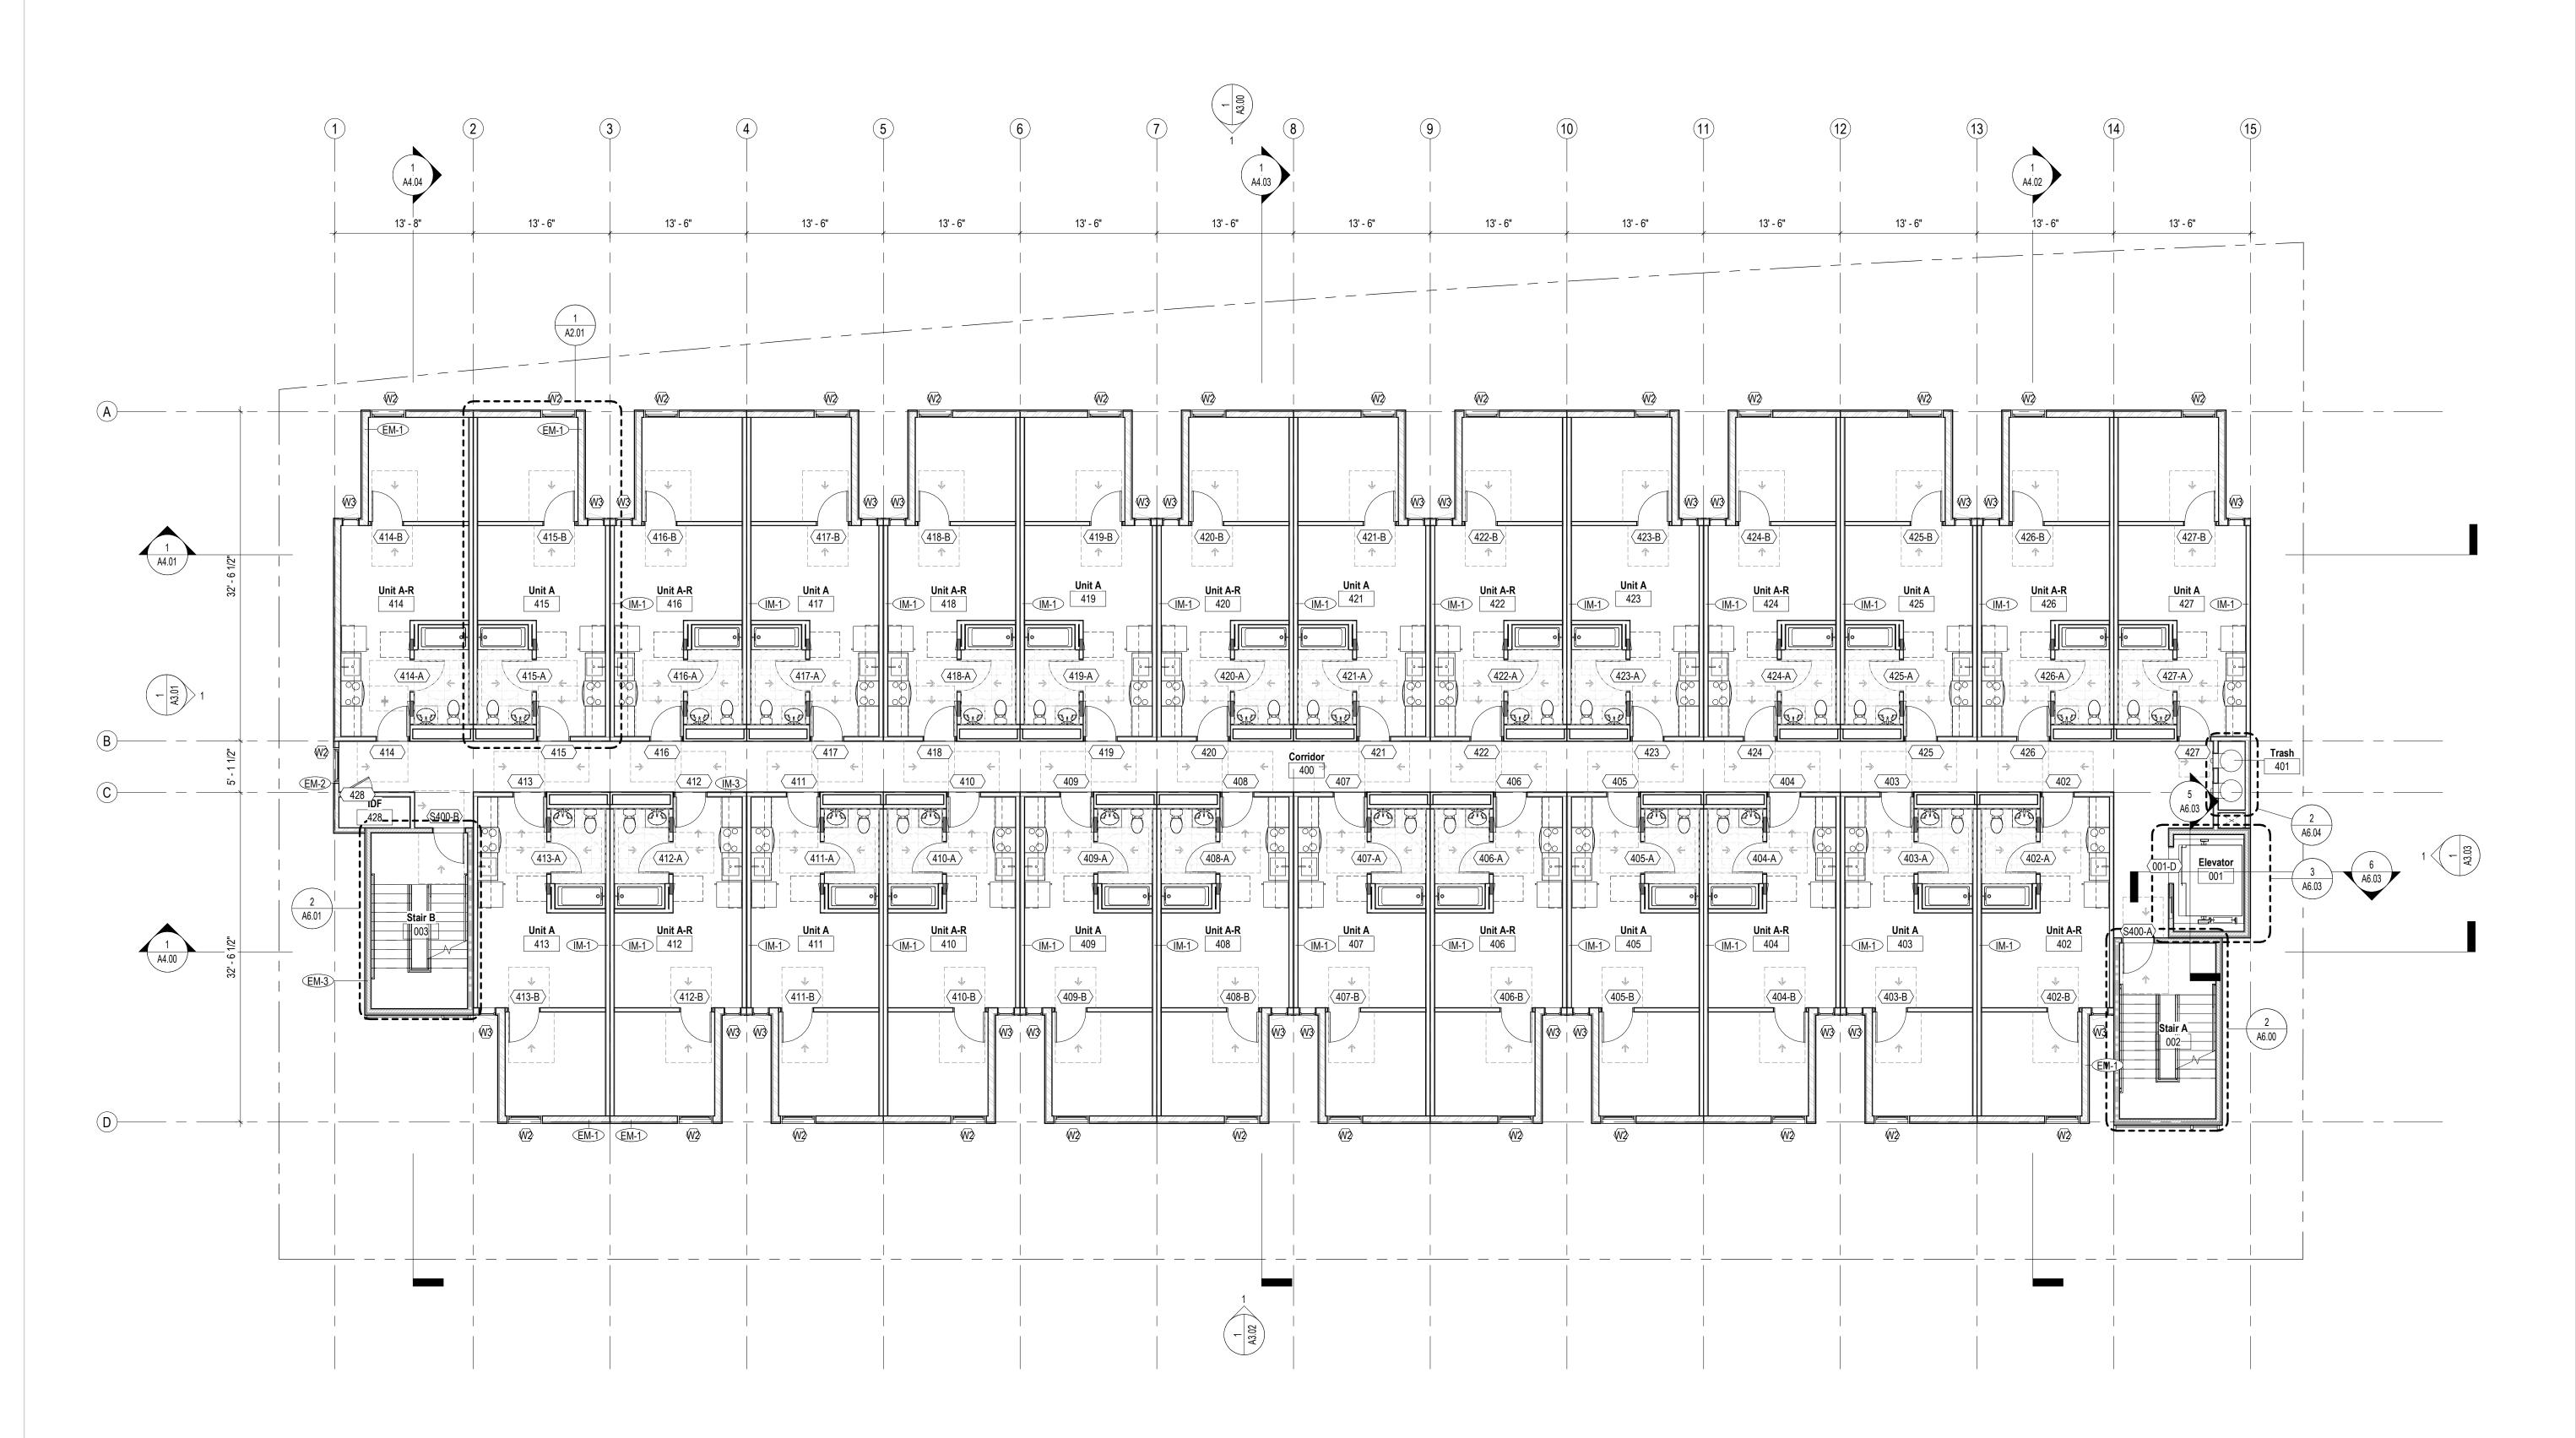
1 Hour Fire Partition 1 Hour Fire Partition 2 Hour Fire Barrier

2 Hour Fire Barrier (Horizontal Exit, Demising Wall) 1 Hour Exterior Wall

1 1/8" = 1'-0" **L03**

PROJECT NO: 202203 DRAWN BY: Author CHECKED BY: Checker SCALE: As indicated

SHEET NO:



Wall Type - Fire Ratings Legend (See Also A0.01-A0.05)
113 1) 1 1 1 1 1 1 1 1 1

General Notes

1. Contractor to notify Architect of any discrepancies prior to start of work. 2. Reference Spec for Product Information and Installation Requirements

4. Verify all dimensions with Structural Drawings and Specification regarding

5. Accessibility Requirements for Private Multifamily Housing is Subject to

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7. Elevator Building Requires All Units, Including Ground-Floor Units, to be

Requirements for All Covered Dwelling Units and Common Use Areas.

Accessible, Adaptable, and on an Accessible Route Complying with CBC

dimensional tolerances. Contract to notify Architect of any discrepacies.

3. Reference Spec for Accessible Parking Stall Requirements

6. Covered Dwelling Units in Compliance with 1102A.2.

1104A and 1106A.

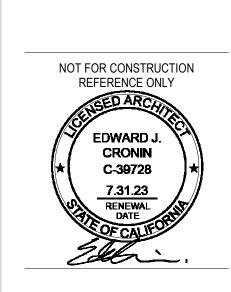
0 Hour Wall 1 Hour Fire Barrier 3 Hour Fire Barrier

2 Hour Fire Barrier

2 Hour Fire Barrier (Horizontal Exit, Demising Wall) 1 Hour Exterior Wall

1 Hour Fire Partition 1 Hour Fire Partition

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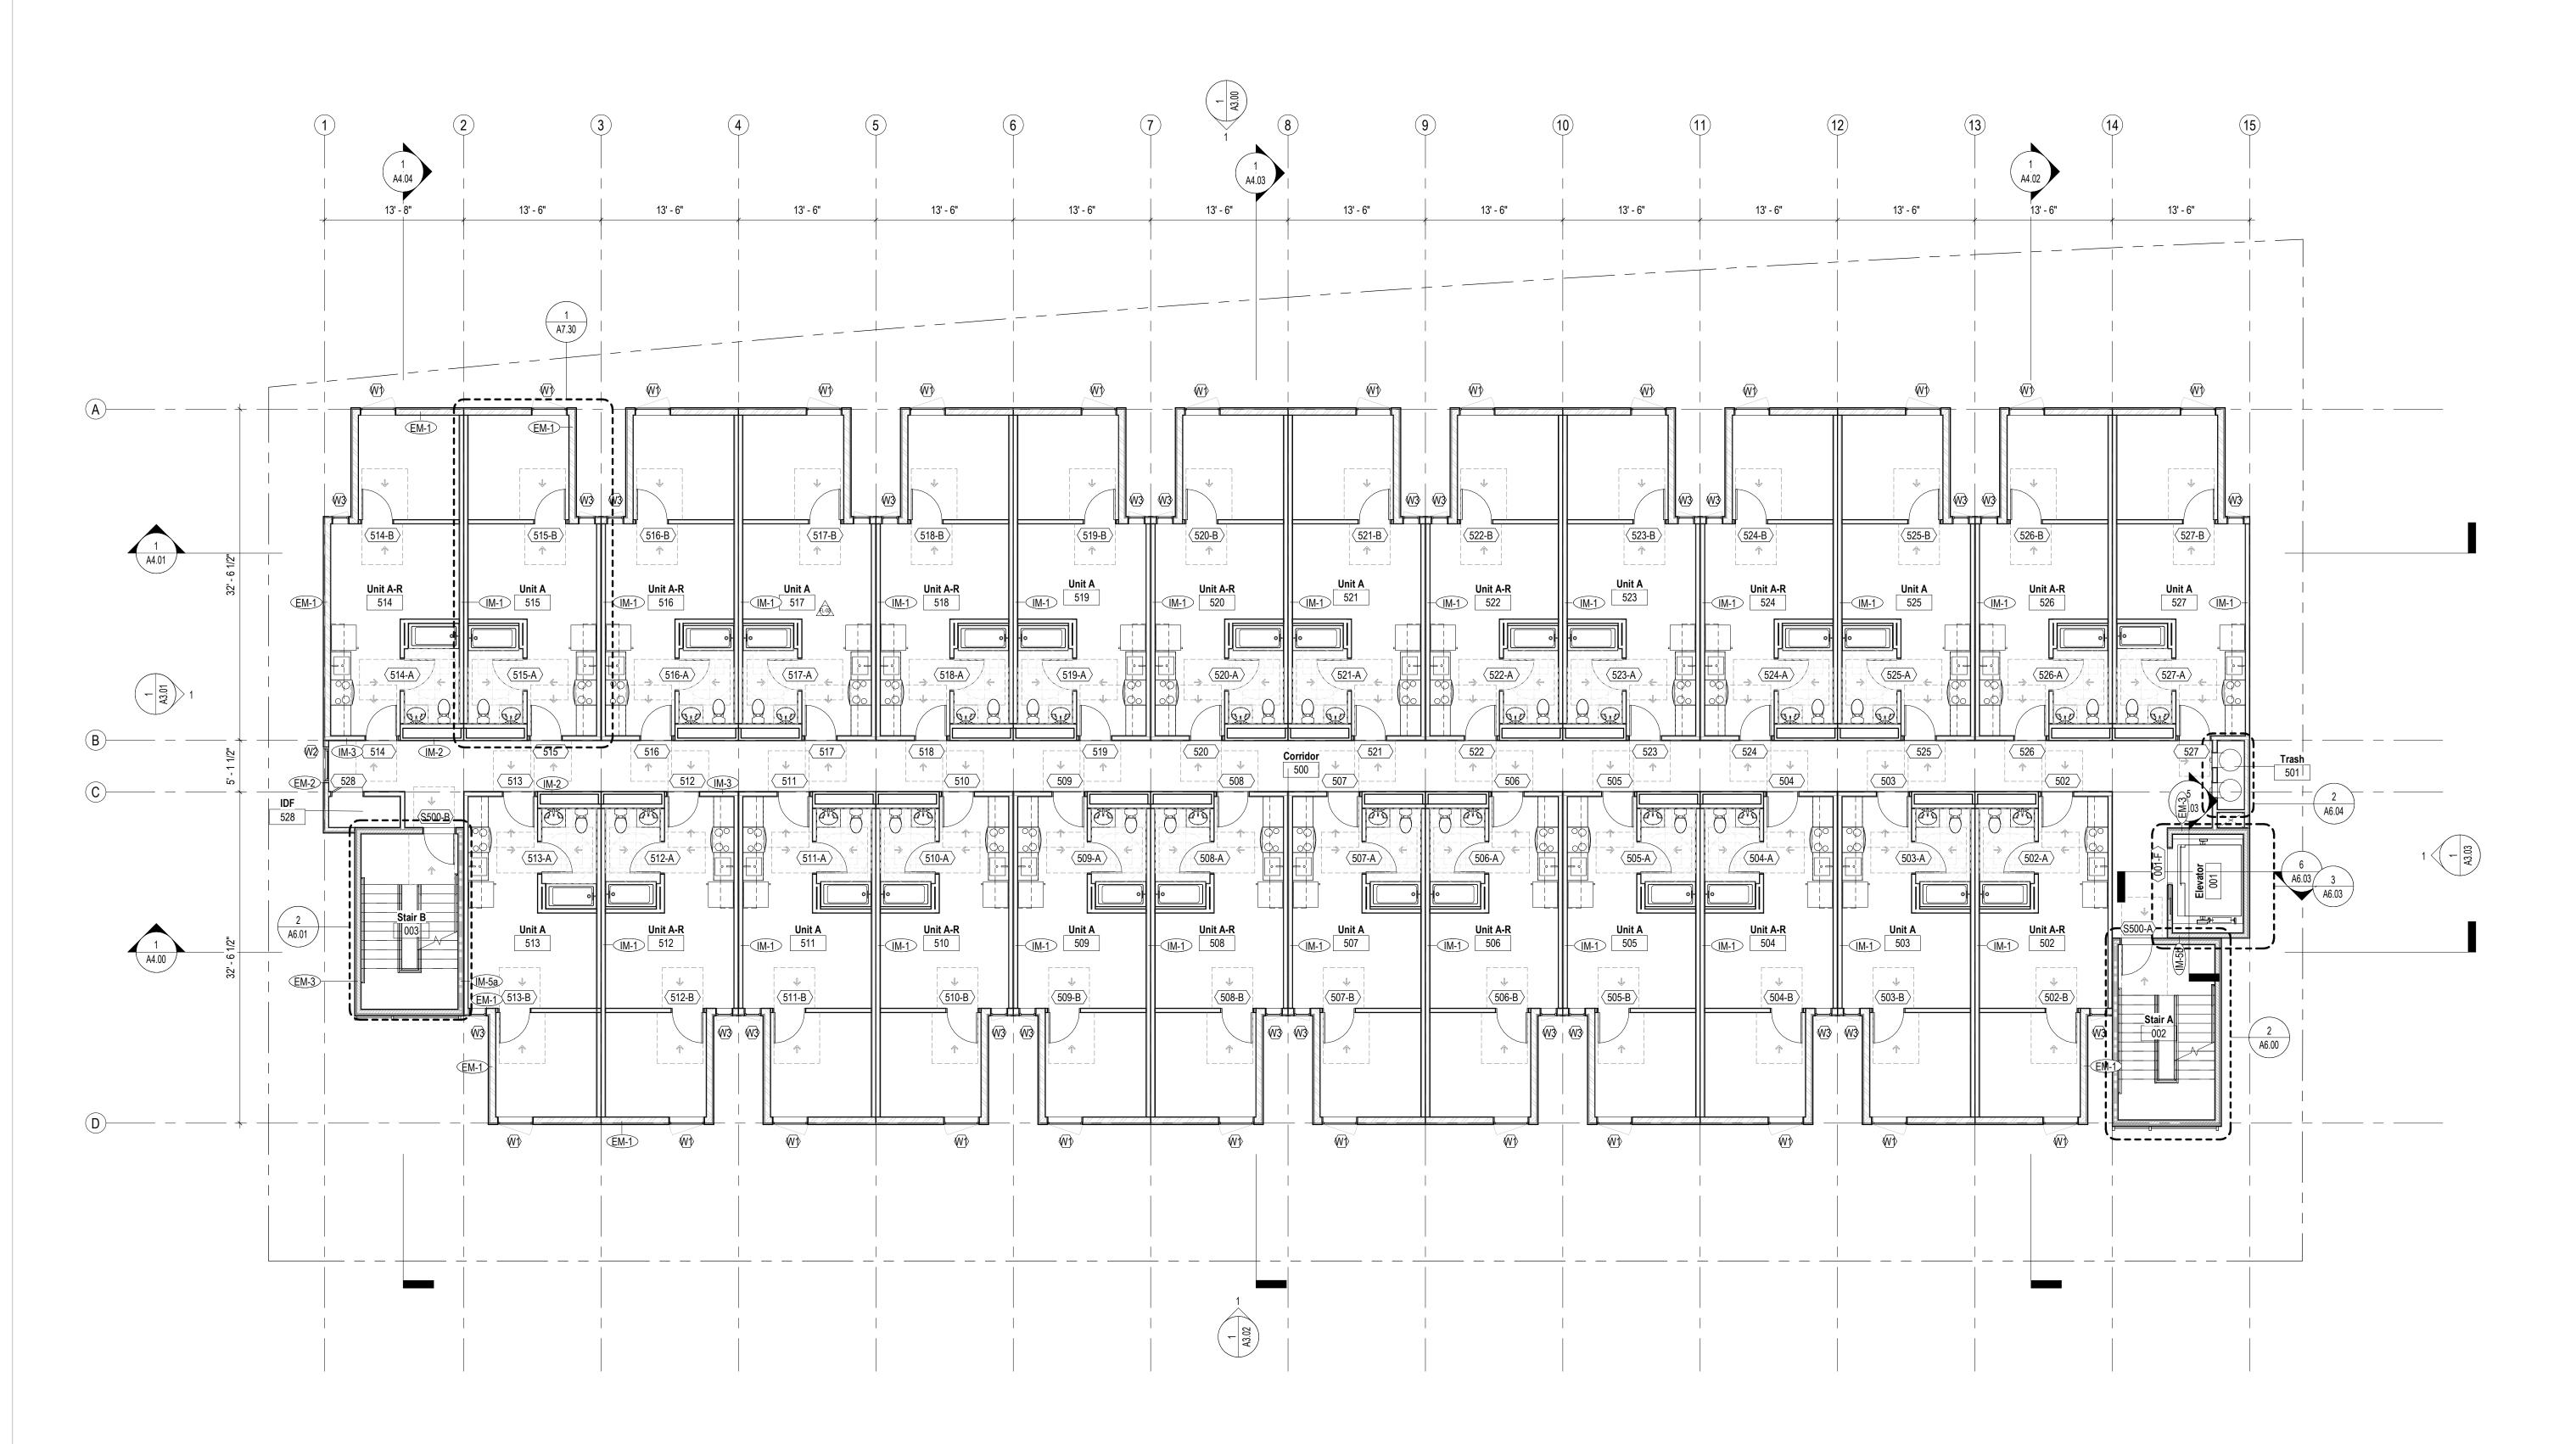
DATE : ISSUE: 11.21.2022 PZA Submittal 12.15.2022 1st Plan check Submittal

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TRUE PLAN NORTH



Wall Type - Fire Ratings Legend	(See Also A0 01-A0 05)
Wall Type The Railings Legeria	(00071130710.01710.00)

0 Hour Wall 1 Hour Fire Barrier 3 Hour Fire Barrier

1 Hour Fire Partition 1 Hour Fire Partition 2 Hour Fire Barrier

2 Hour Fire Barrier (Horizontal Exit, Demising Wall) 1 Hour Exterior Wall

General Notes

1. Contractor to notify Architect of any discrepancies prior to start of work. Reference Spec for Product Information and Installation Requirements

4. Verify all dimensions with Structural Drawings and Specification regarding

5. Accessibility Requirements for Private Multifamily Housing is Subject to

CBC 11A, FHA, and ADA. Ref GN0.03 for Additional Accessibility

7. Elevator Building Requires All Units, Including Ground-Floor Units, to be

Requirements for All Covered Dwelling Units and Common Use Areas.

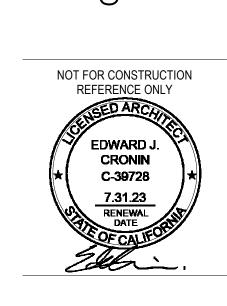
Accessible, Adaptable, and on an Accessible Route Complying with CBC

dimensional tolerances. Contract to notify Architect of any discrepacies.

3. Reference Spec for Accessible Parking Stall Requirements

6. Covered Dwelling Units in Compliance with 1102A.2.

1104A and 1106A.



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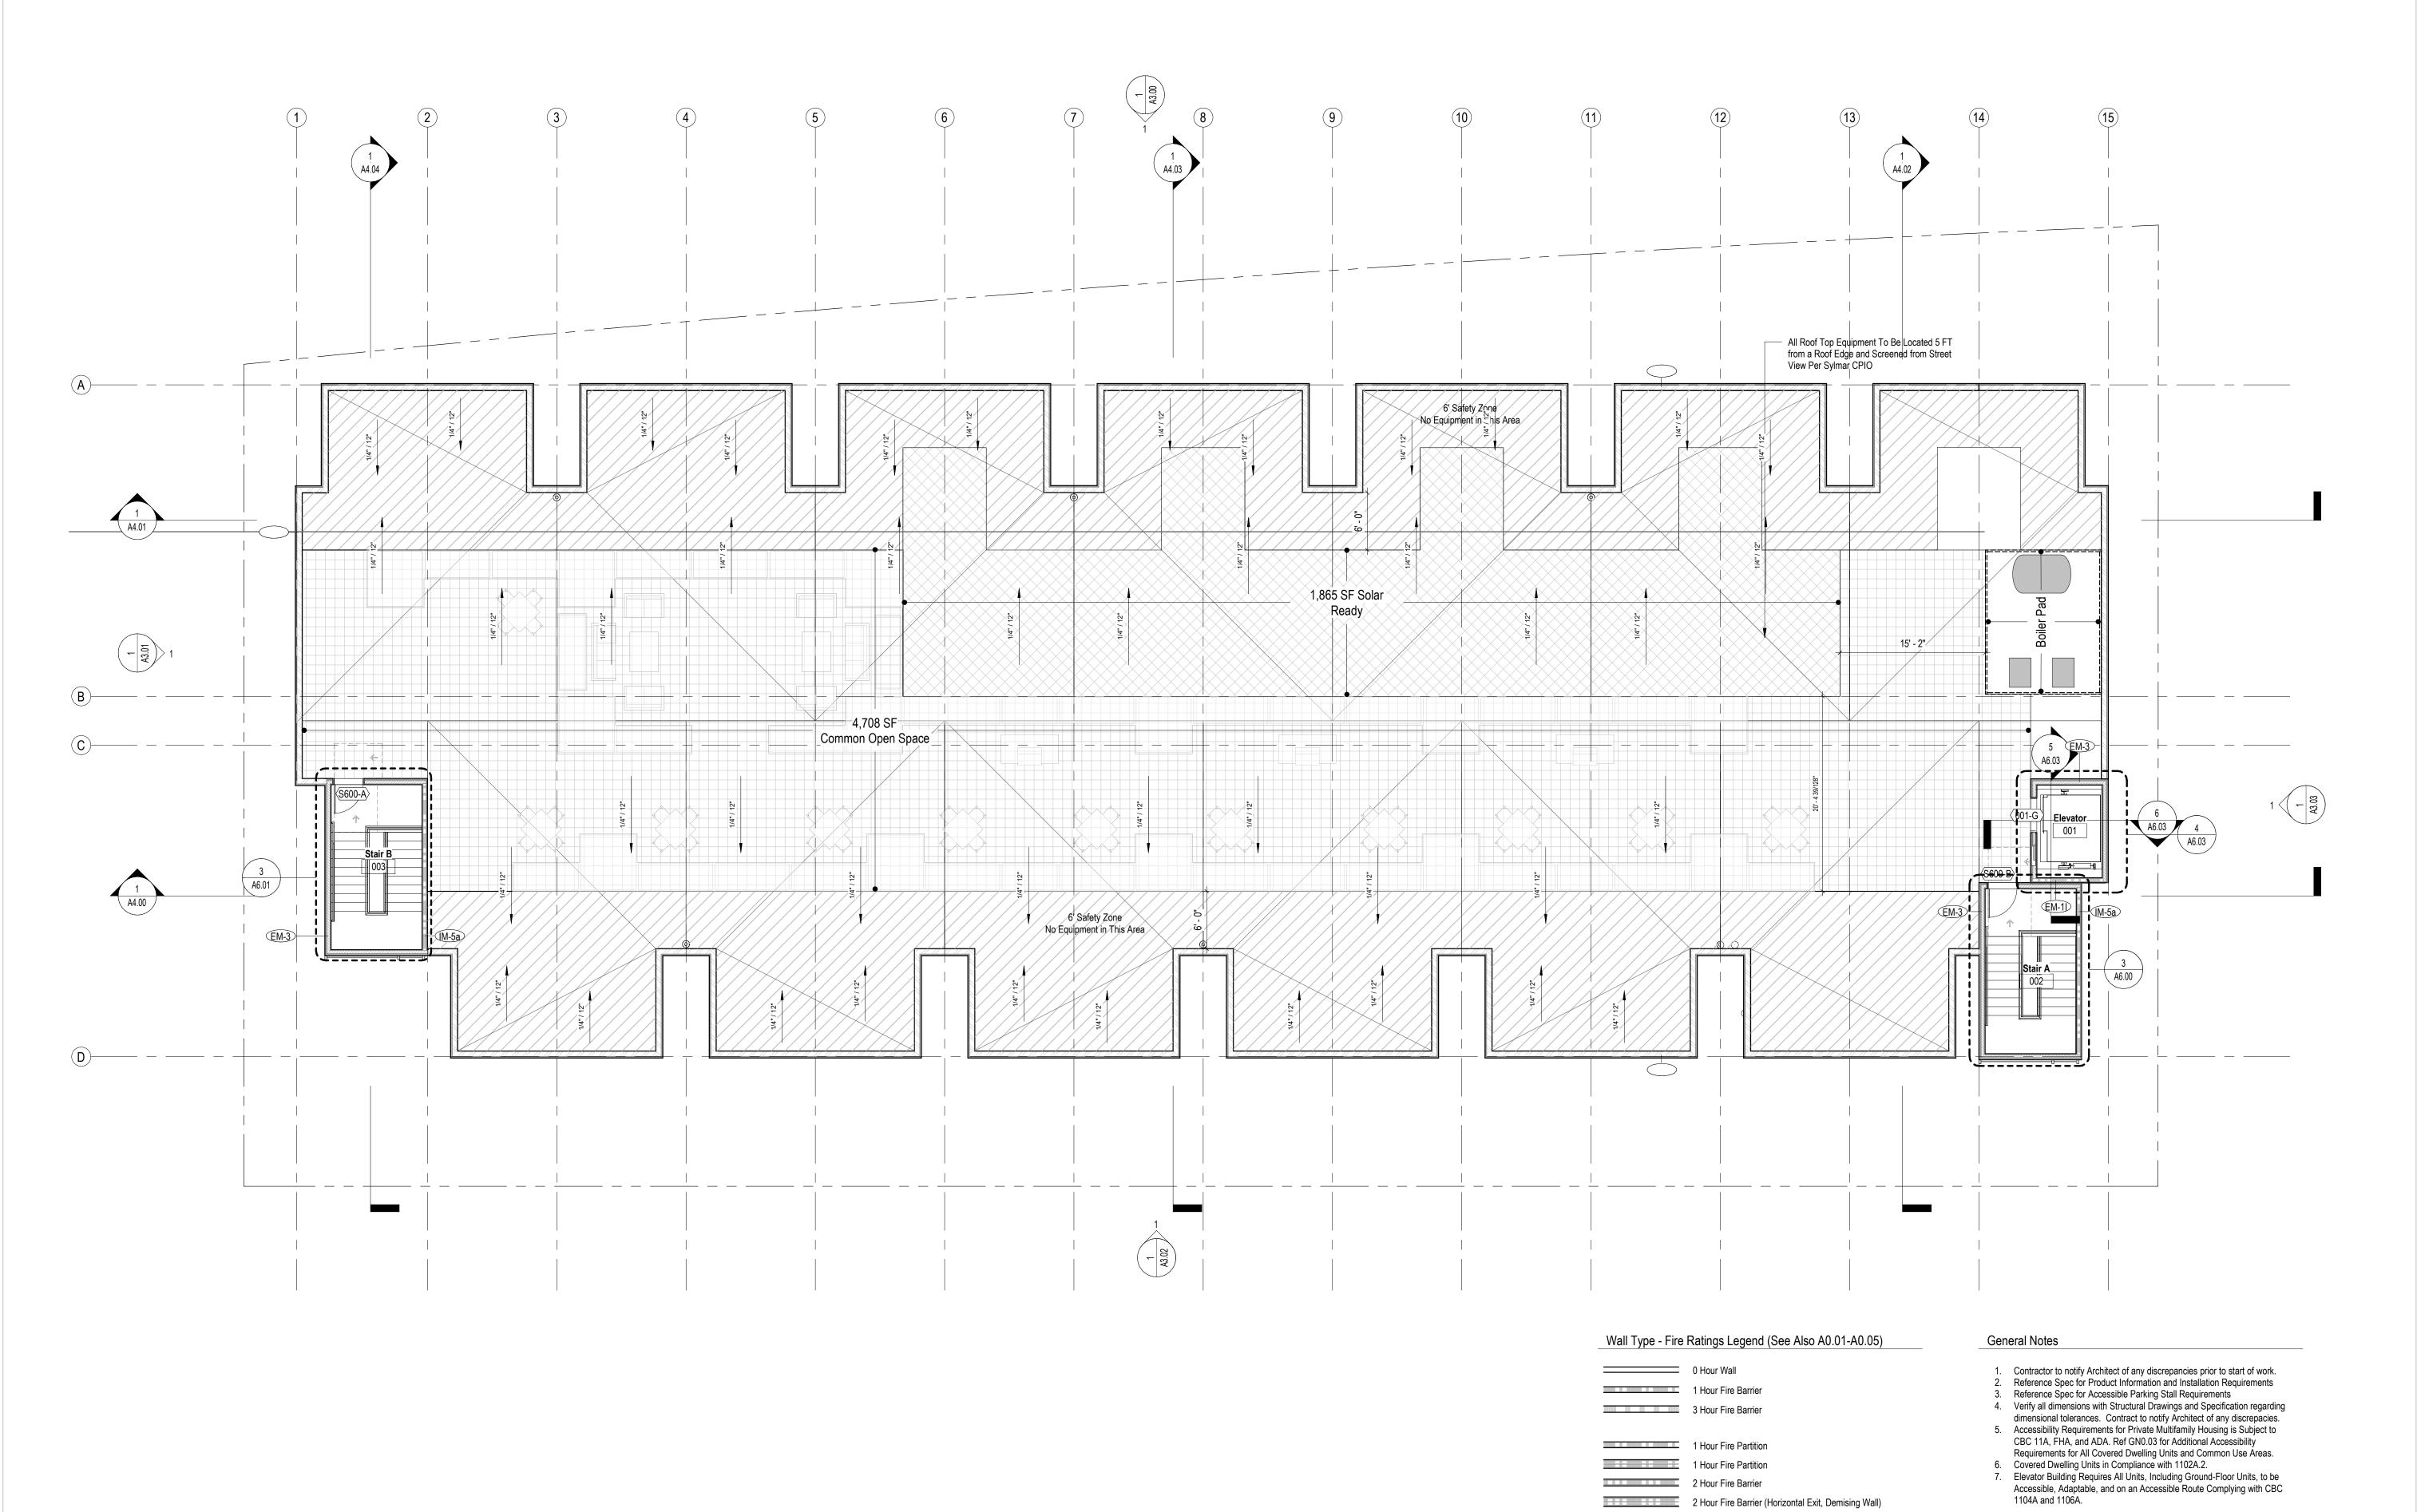
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1 Hour Exterior Wall

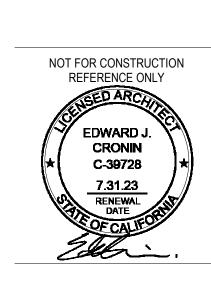
 New buildings shall have approved address numbers, building numbers or approved building identification placed in a position that is plainly legible and visible from the street or road fronting the property. These numbers shall contrast with their background and be a minimum of 4 inches high with a minimum stroke width of 0.5 inches. OPEN office

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verall Exterior Elevations



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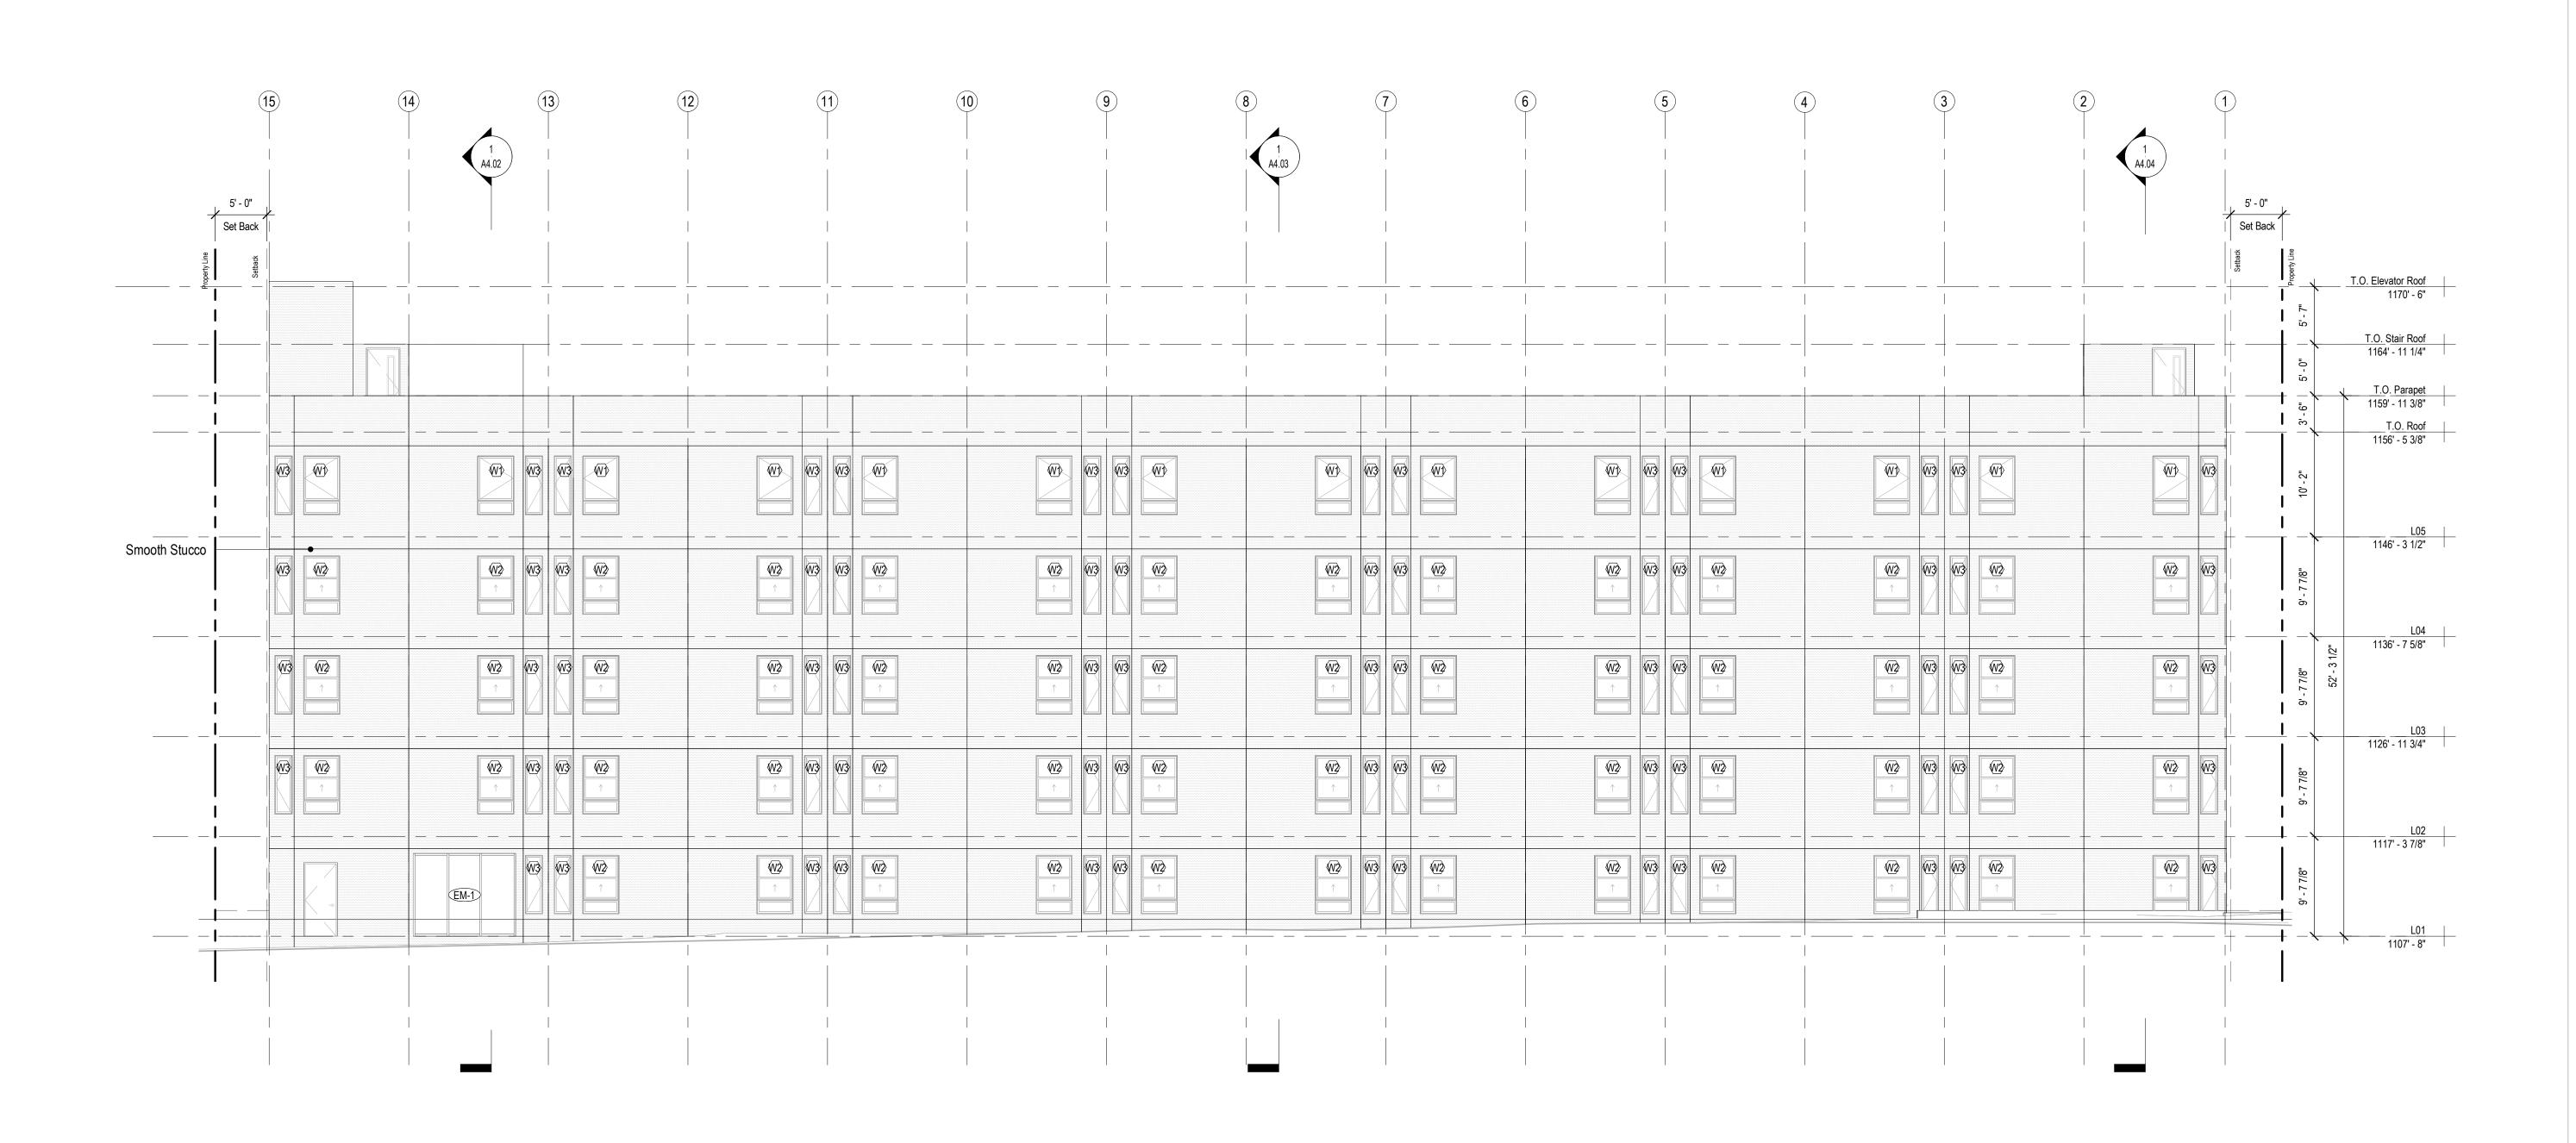
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A3.00



General Notes

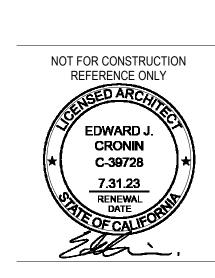
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Verall Exterior Elevations



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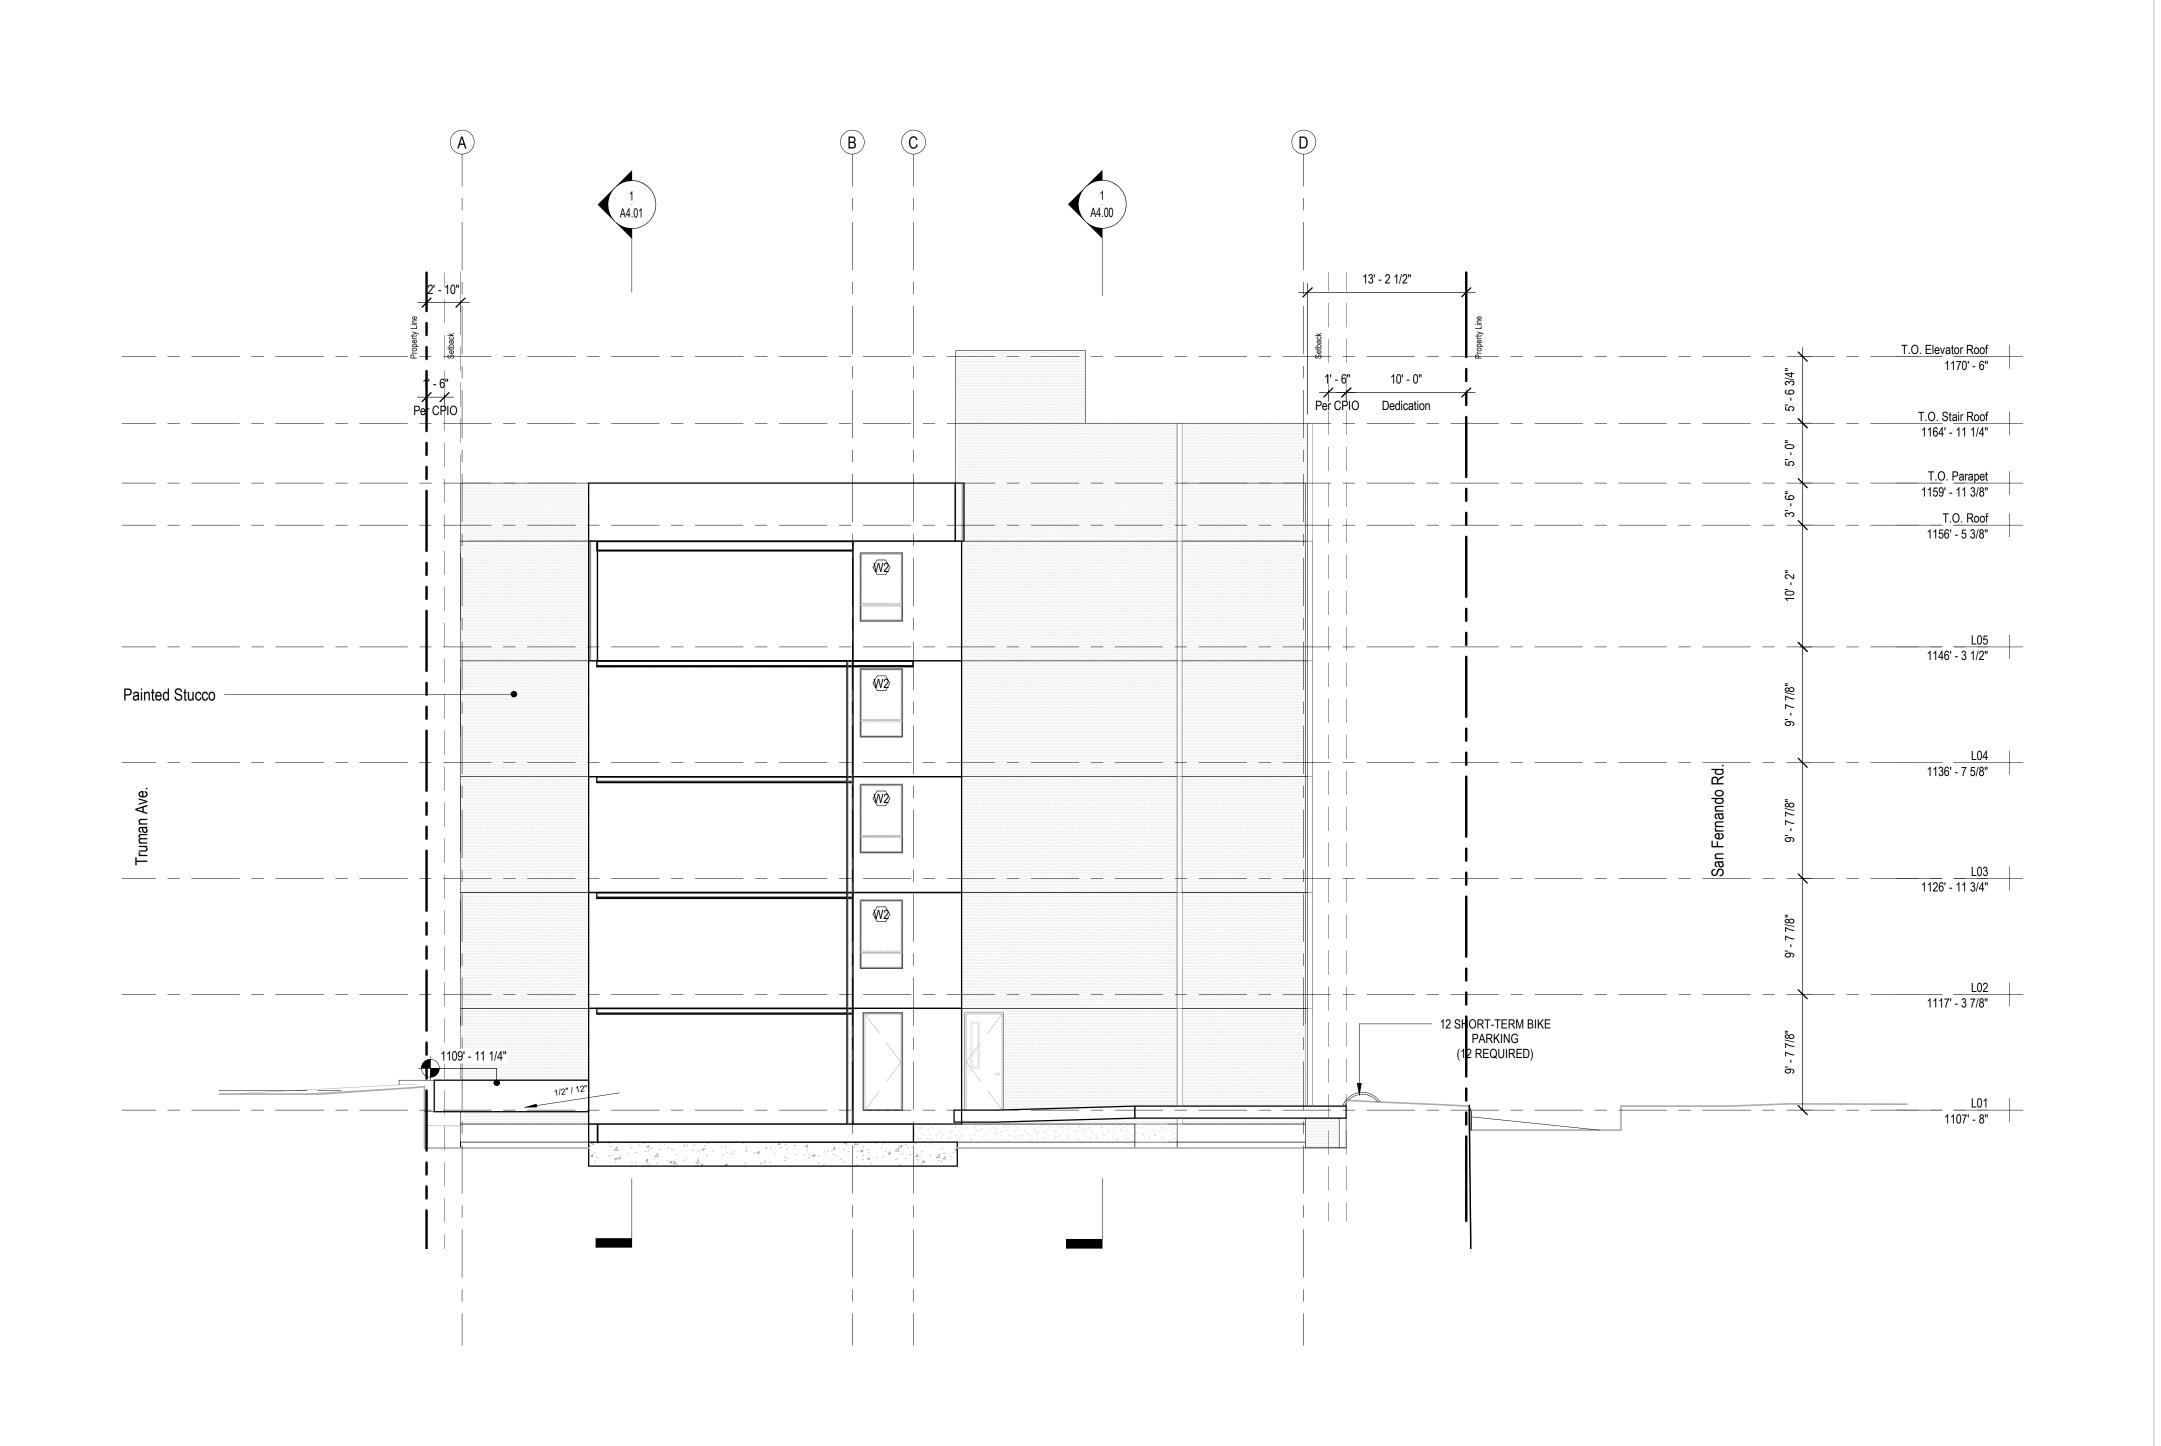
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A3.01



5' - 0"

Set Back

T.O. Elevator Roof 1170' - 6"

T.O. Stair Roof 1164' - 11 1/4"

T.O. Parapet 1159' - 11 3/8"

T.O. Roof 1156' - 5 3/8"

L05 1146' - 3 1/2"

L04 1136' - 7 5/8"

L03 1126' - 11 3/4"

L02 1117' - 3 7/8"

L01 1107' - 8"

Legend

Painted Stucco

Concrete

Vertical Hardie Siding

Wire Mesh Panel

Sheet Metal Reveal

W W W W

(W2) (W3) (W3) (W2)

₩**>** ₩**>** ₩**>** ₩**>**

₩**>** ₩**>** ₩**>** ₩**>**

W3 W3

(1 A4.02)

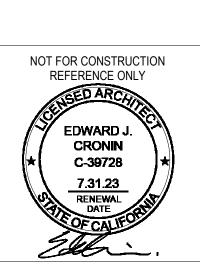
₩**>**

₩**>** ₩**3**

₩**≥** ₩**3**

12 SHORT-TERM BIKE PARKING (11 REQUIRED)

Ptd. Concrete



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1 1/8" = 1'-0" South Elevation - Exterior Elevation

5' - 0"

Stucco -

Set Back

| W3 | W5

(W) (W) (W)

₩**>** ₩**>** ₩**>**

(W2) (W3) (W3) (W2)

₩₩₩₩₩

(W2) (W3) (W3) (W2)

(W2) (W3) (W2)

₩**3** ₩**3** ₩**2**

Wh W3 W3 Wh

(W2) (W3) (W3) (W2)

(W2) (W3) (W2)

₩**3** ₩**3** ₩**3**

(W) (W) (W) (W)

A3.02

(W) (W3 (W3 (W)

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(V2) (V3) (V3) (V2)

(W3) (W3) (W3)

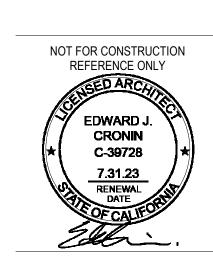
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verall Exterior Elevations



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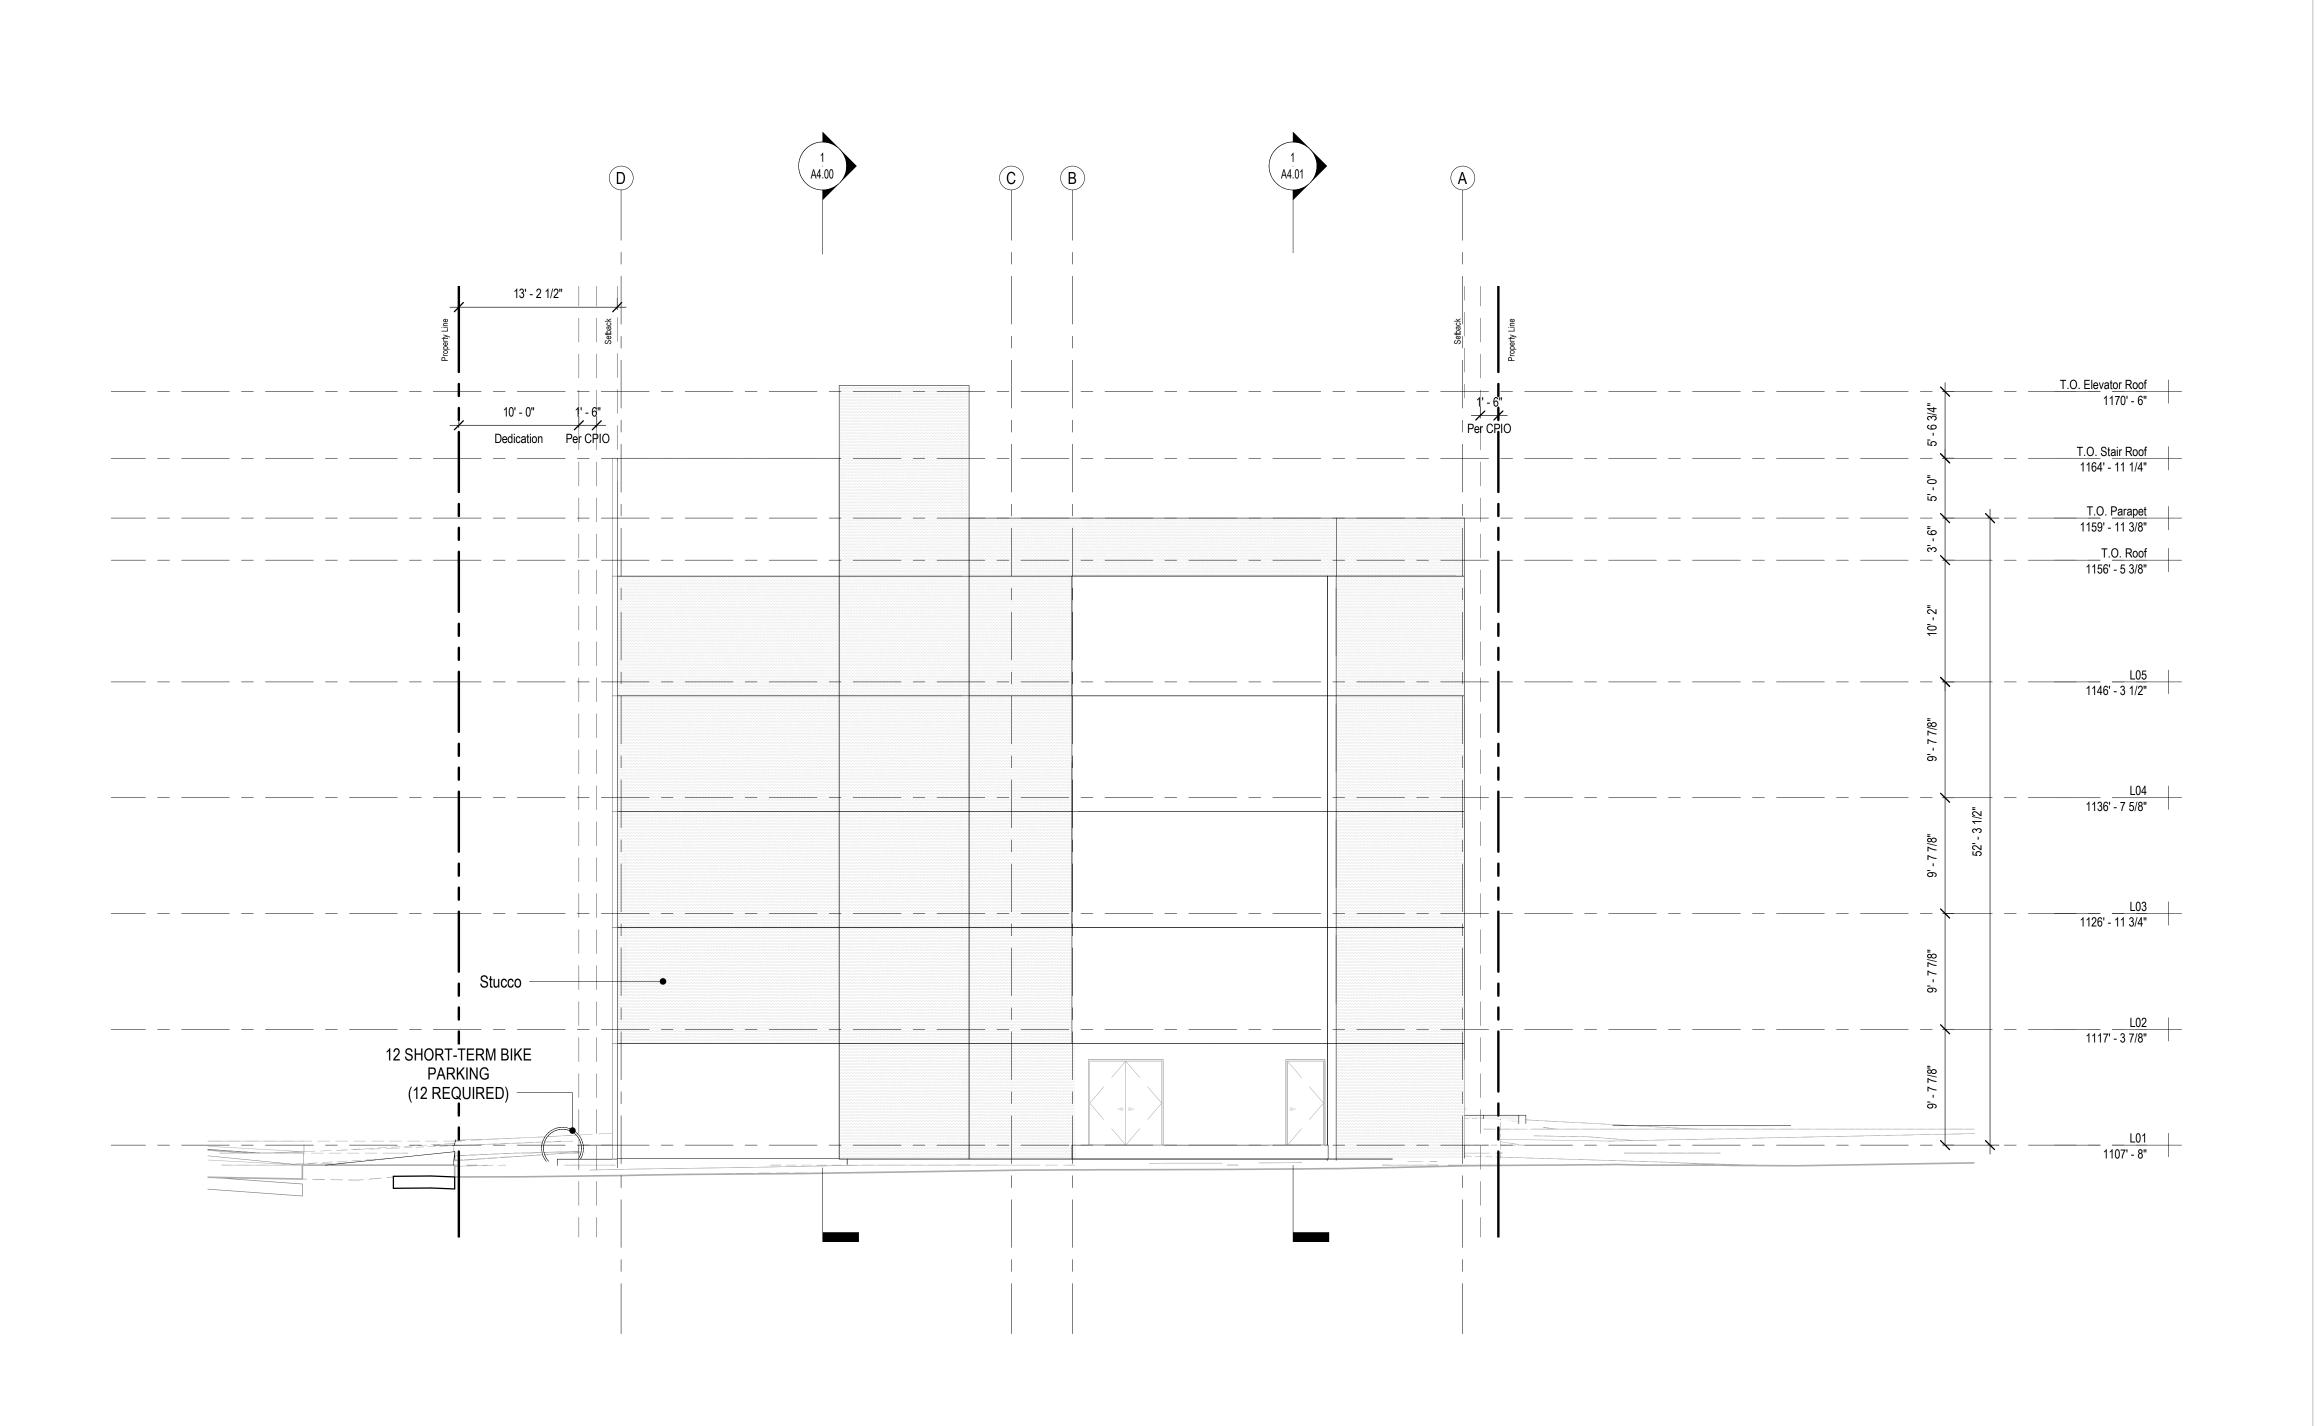
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A3 03



General Notes

and visible from the street or road fronting the property. These numbers

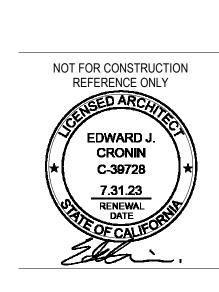
shall contrast with their background and be a minimum of 4 inches high

with a minimum stroke width of 0.5 inches.

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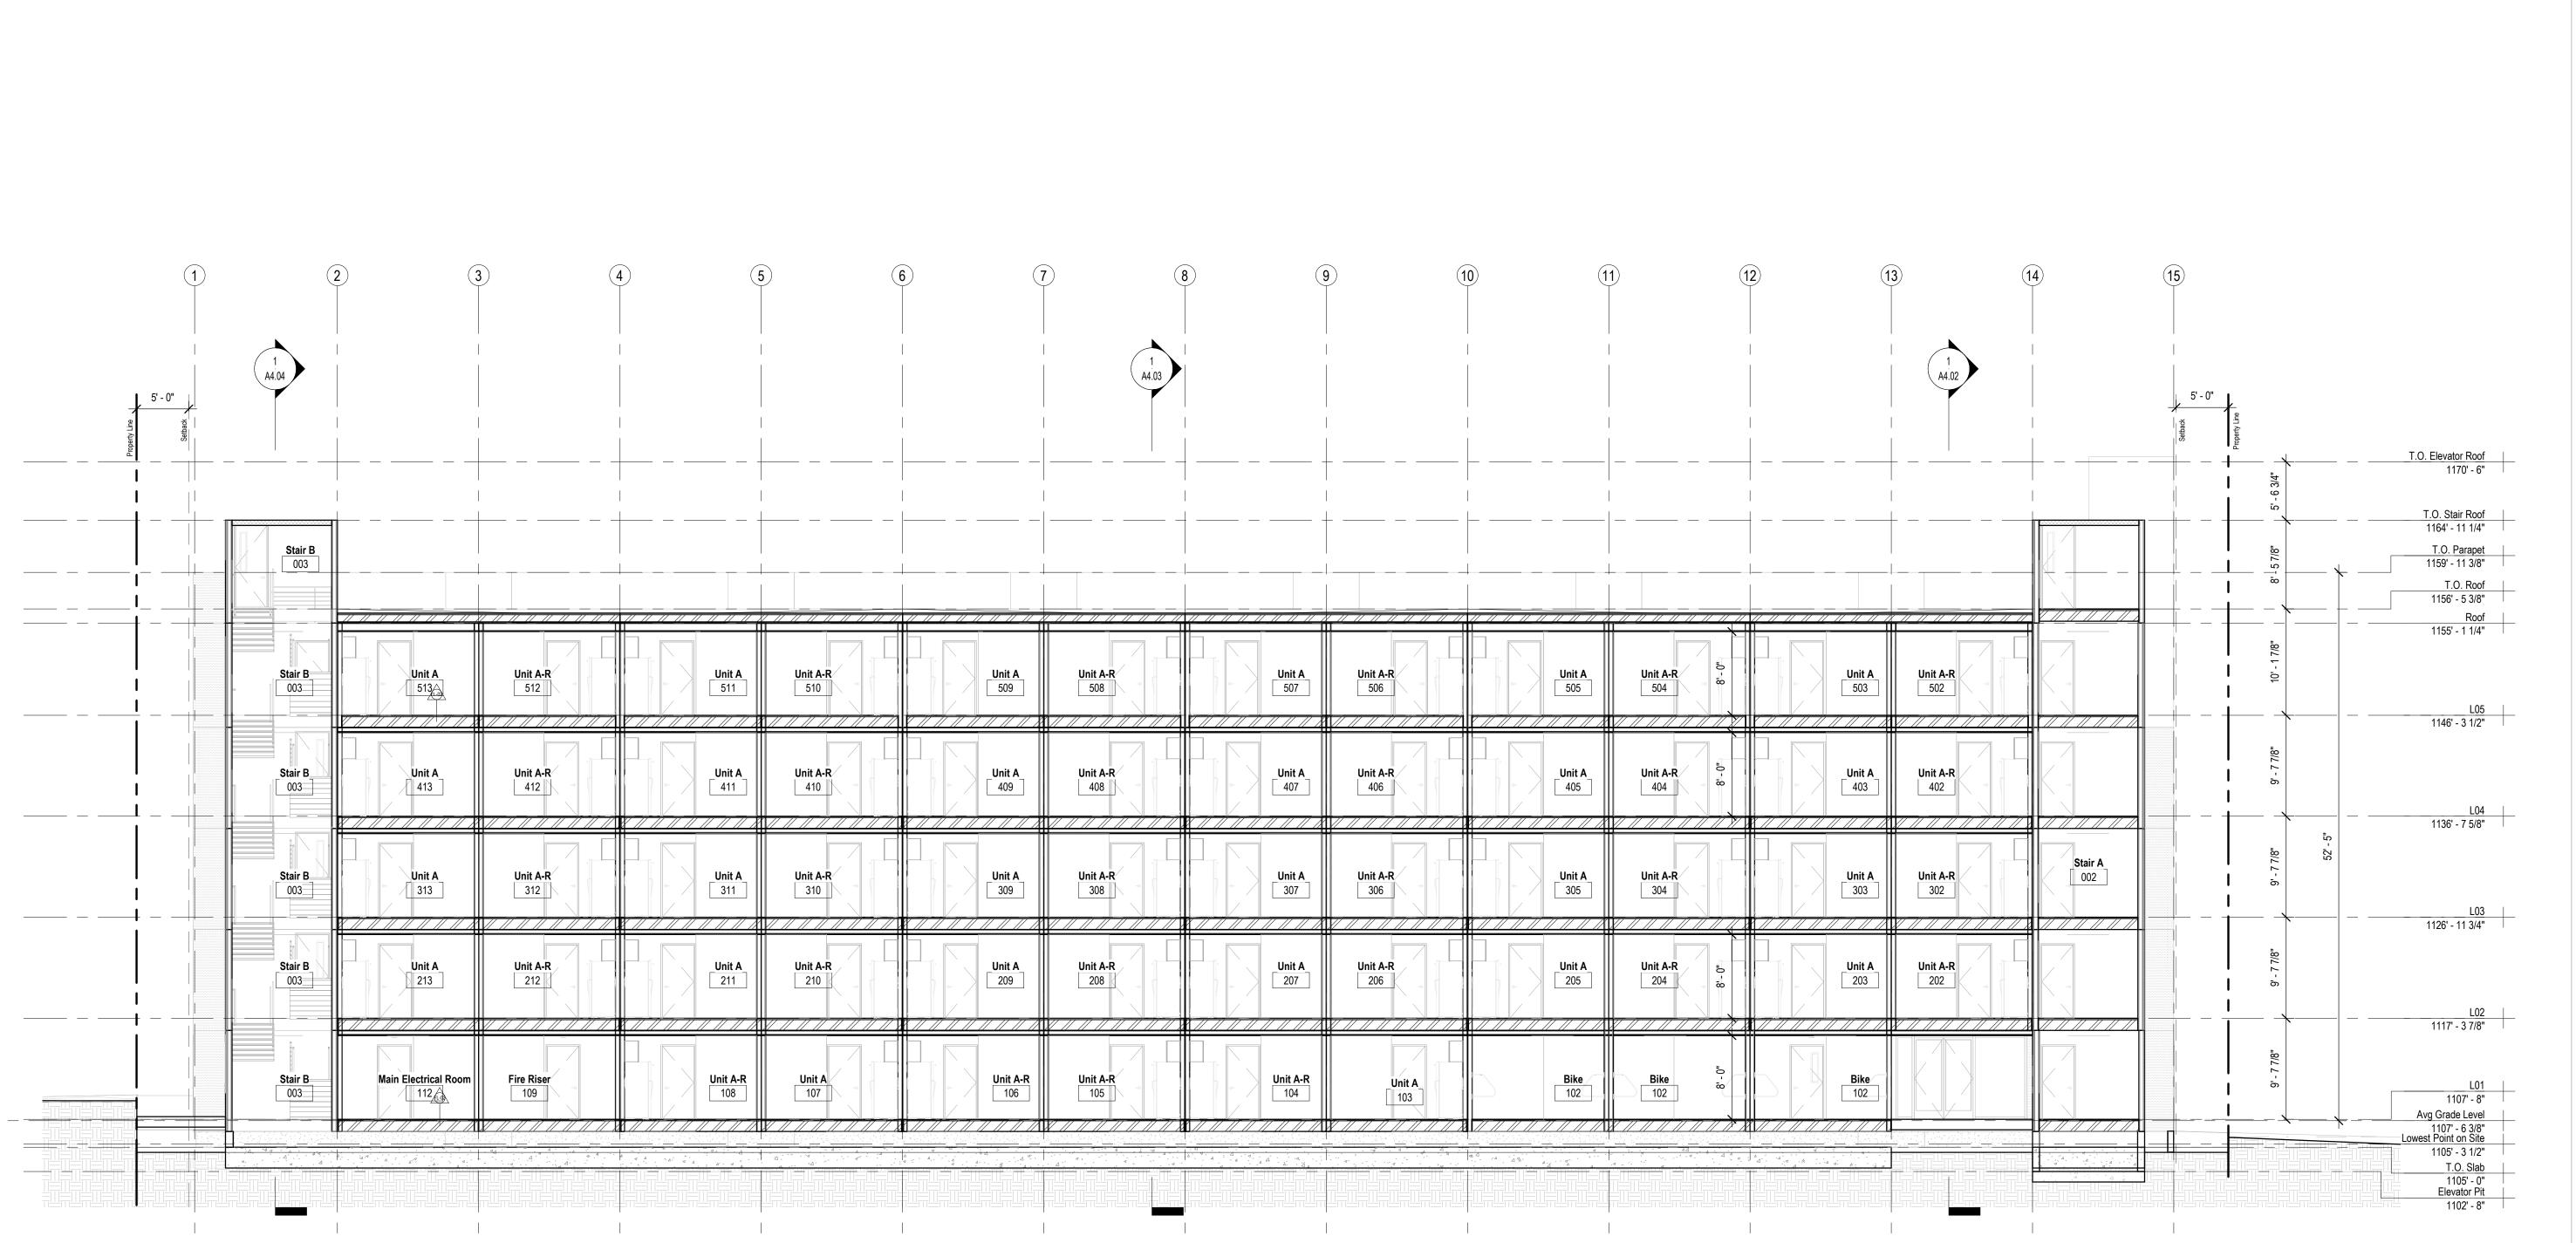
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Legend

Painted Stucco

Concrete

Vertical Hardie Siding

Wire Mesh Panel

Sheet Metal Reveal

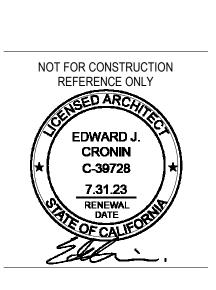
Ptd. Concrete

shall contrast with their background and be a minimum of 4 inches high

with a minimum stroke width of 0.5 inches.

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SHEET NO:

1 1/8" = 1'-0" Section B North - South

Unit A-R

514

414

Unit A-R 314

Unit A-R

Unit A

113

214

515

415

315

516

416

Unit A-R 316

Unit A-R

216

Unit A-R

115

417

Unit A

Unit A 217

• Unit A • 116

- 116

T.O. Elevator Roof 1170' - 6" T.O. Stair Roof 1164' - 11 1/4" T.O. Parapet 1159' - 11 3/8" T.O. Roof 1156' - 5 3/8" Roof 1155' - 1 1/4" Unit A-R Unit A-R 524 525 527 L05 1146' - 3 1/2" 424 425 Unit A-R 426 427 1136' - 7 5/8" **Unit A-R** 324 Unit A-R 326 Unit A 325 L03 1126' - 11 3/4" Unit A-R Unit A-R 224 225 227 226 L02 **Unit A-R** 123 **Electrical Room** Recreation Space !! L01 1107' - 8" 125 126

Legend

Painted Stucco

Concrete

Vertical Hardie Siding

Wire Mesh Panel

Sheet Metal Reveal

Ptd. Concrete

Unit A-R 522 523

422

423

Unit A-R 322 323

223

122

Unit A-R 121

Unit A-R

222

Unit A 120

Unit A-R

520

420

Unit A-R 320

Unit A-R

220

Unit A-R

119

Unit A 521

421

Unit A 321

221

Unit A-R

518

418

Unit A-R 318

Unit A-R

218

Unit A-R

117

519

419

Unit A 319

219

118

Avg Grade Level 1107' - 6 3/8" Lowest Point on Site

1105' - 3 1/2"

T.O. Slab 1105' - 0" Elevator Pit 1102' - 8"

and visible from the street or road fronting the property. These numbers shall contrast with their background and be a minimum of 4 inches high

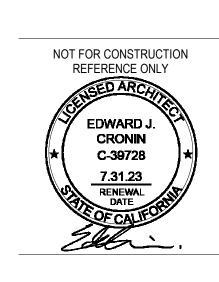
with a minimum stroke width of 0.5 inches.

General Notes

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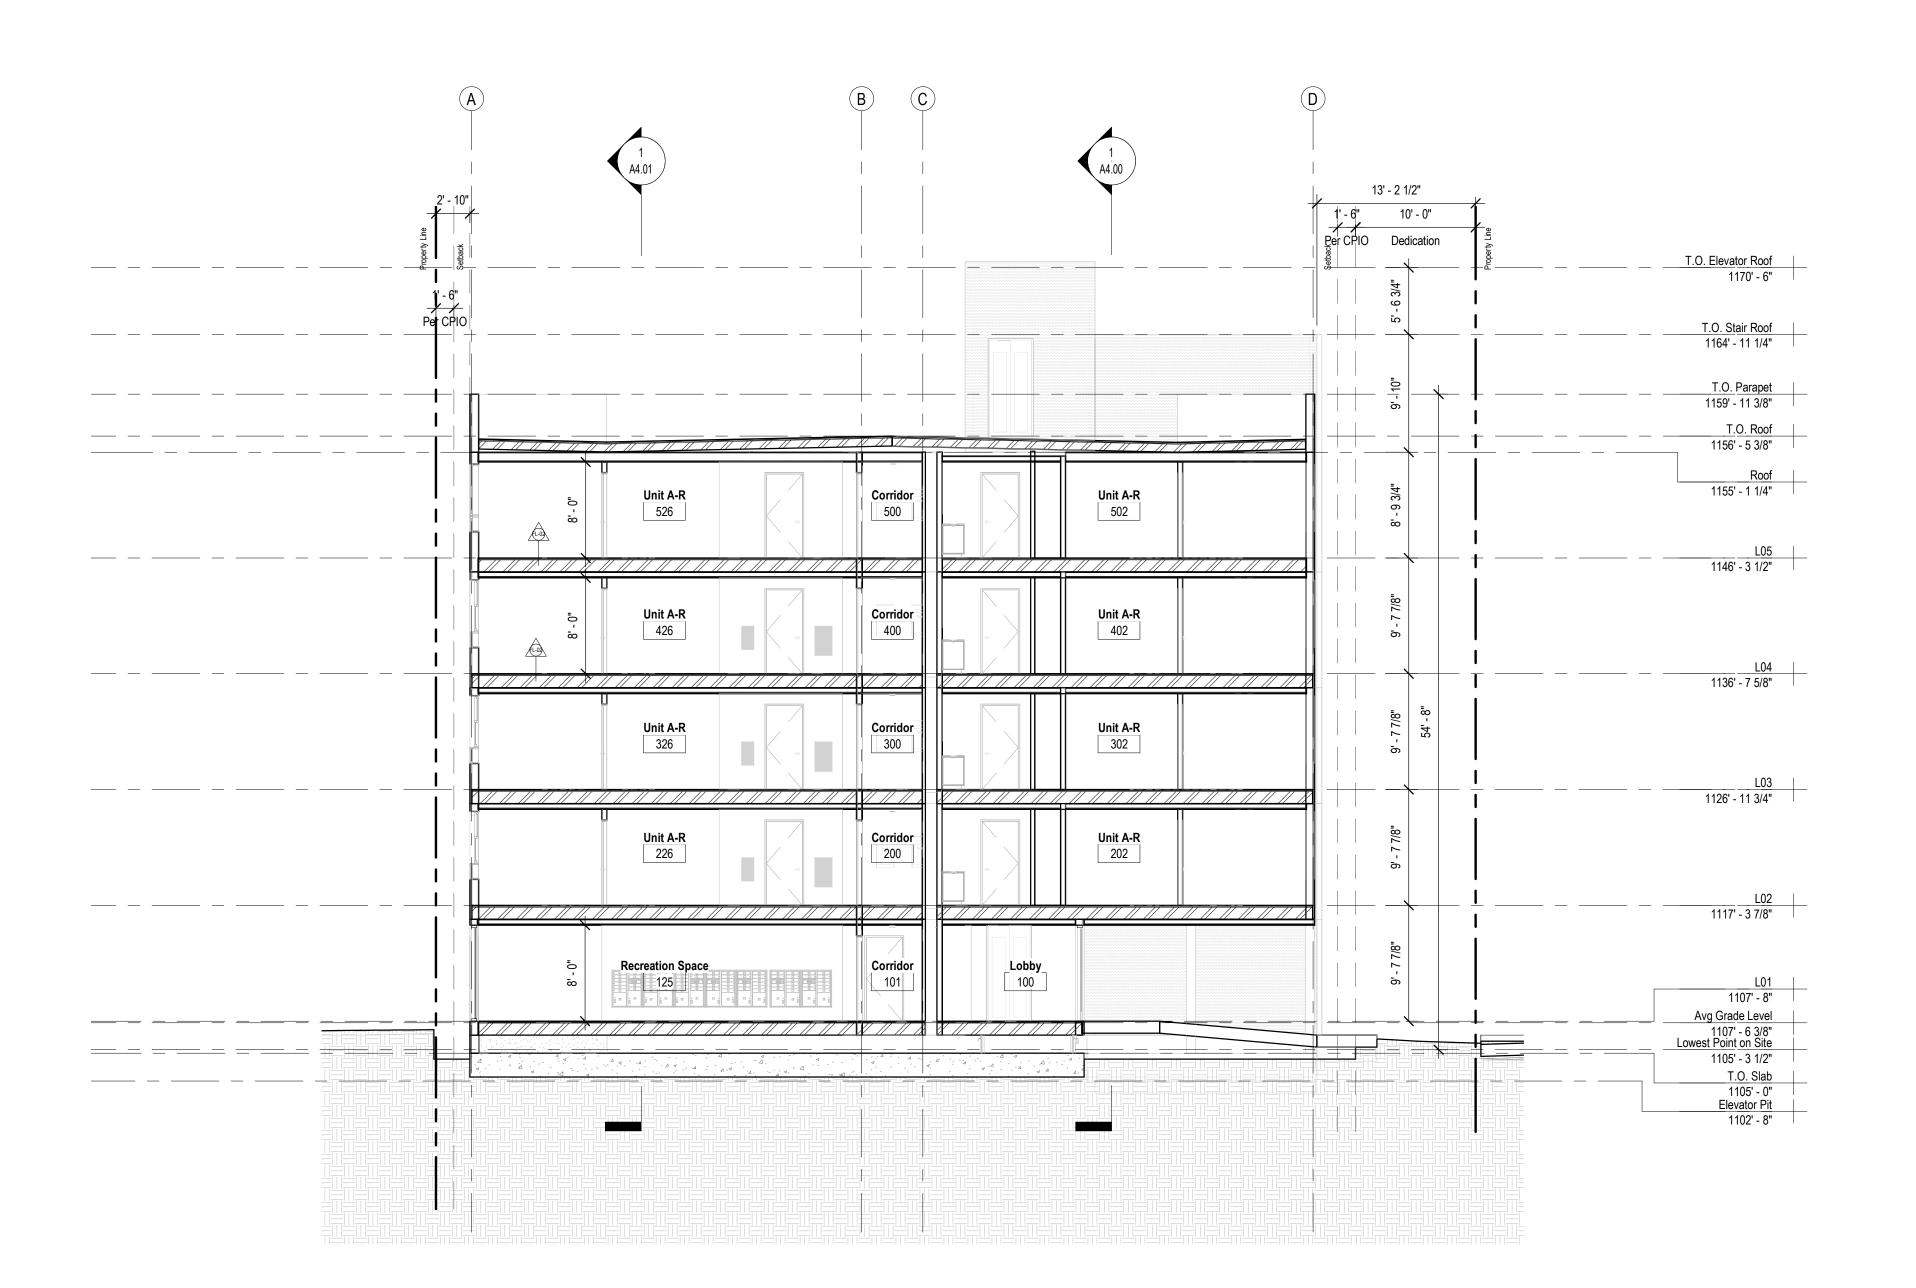


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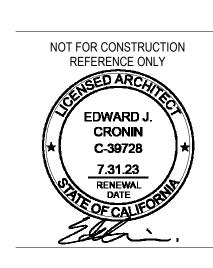
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Legend Painted Stucco Vertical Hardie Siding Concrete Wire Mesh Panel Sheet Metal Reveal Ptd. Concrete



General Notes

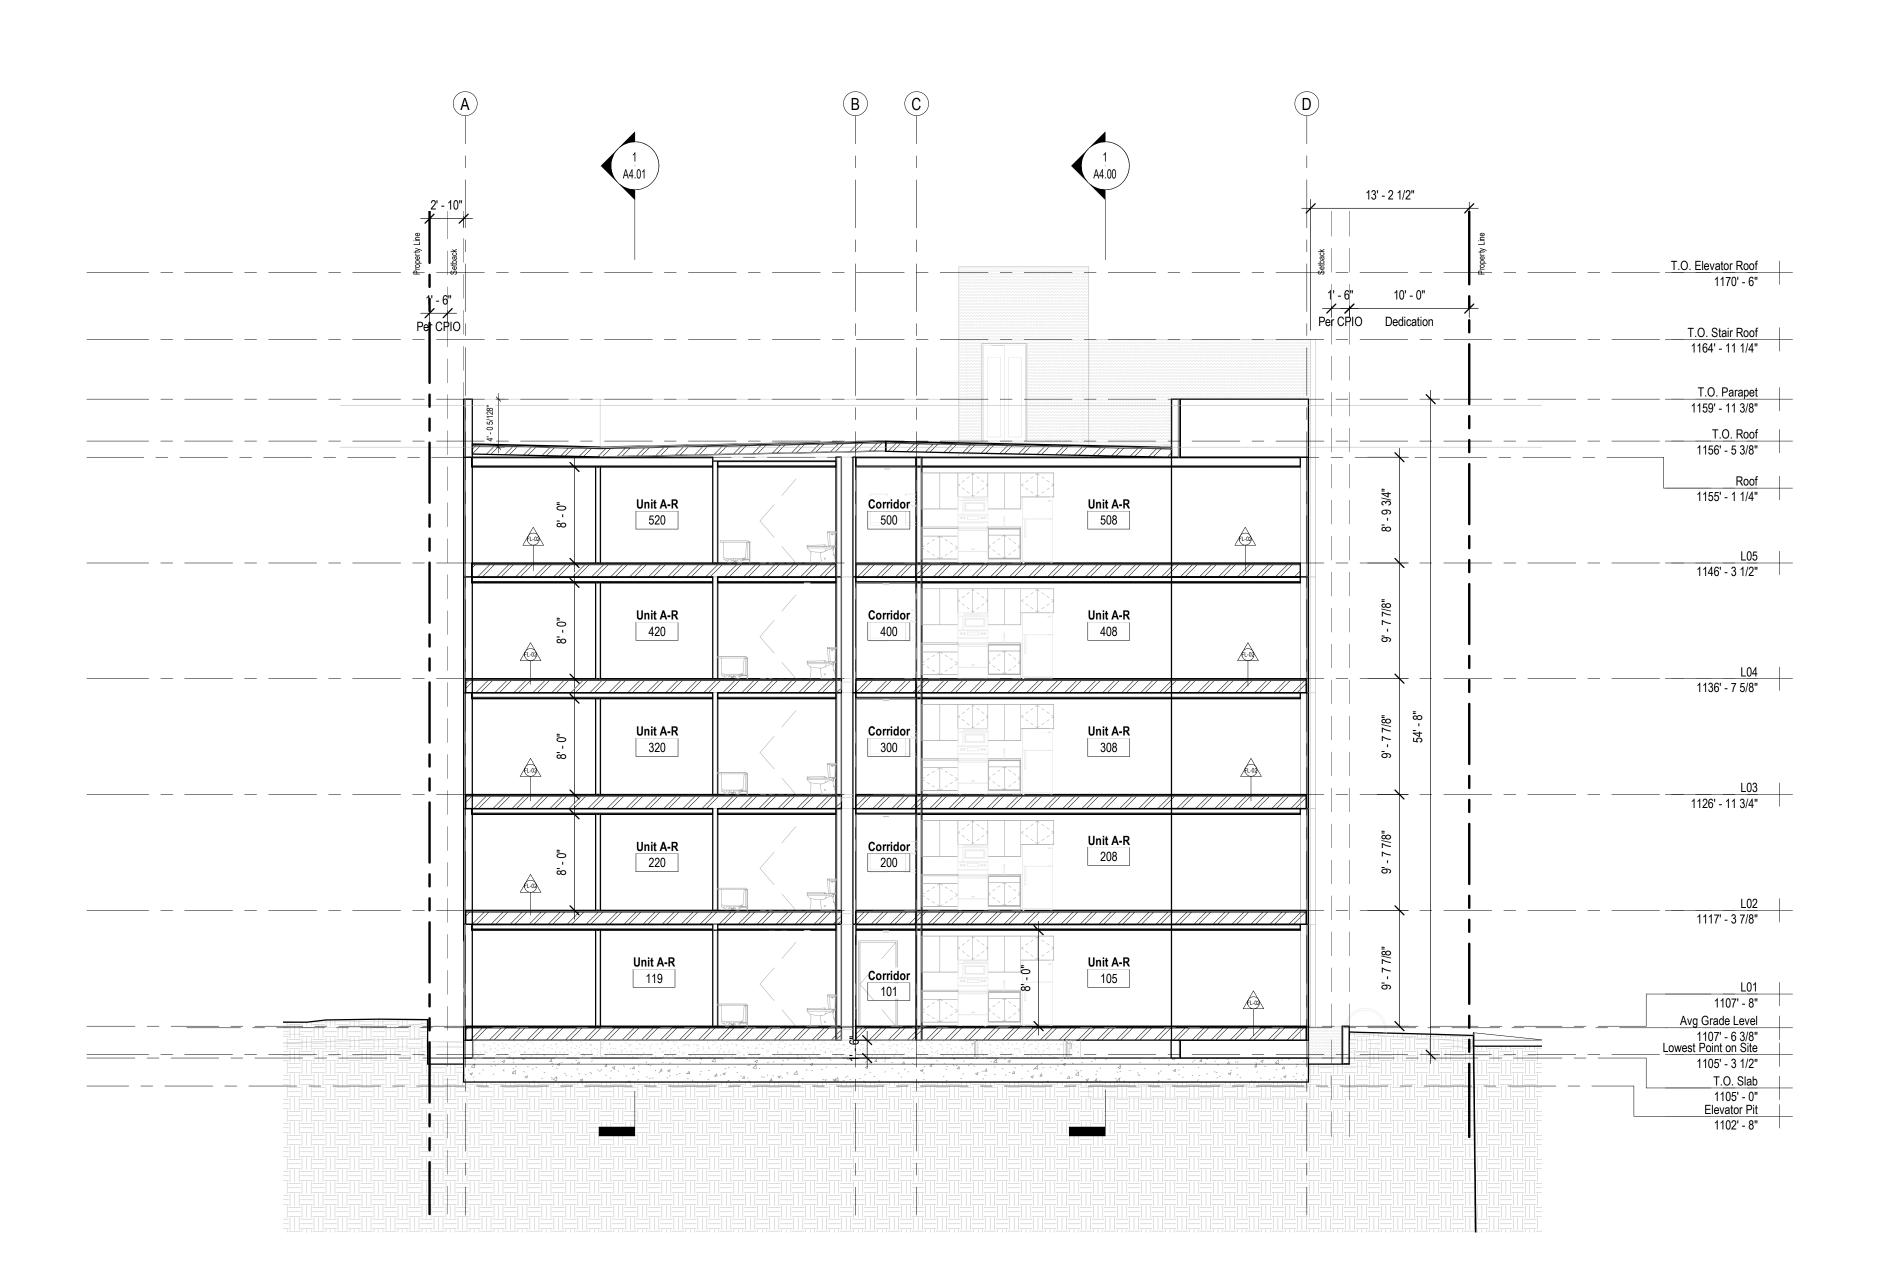


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Legend Painted Stucco Vertical Hardie Siding Concrete Wire Mesh Panel Sheet Metal Reveal Ptd. Concrete



Legend

Painted Stucco

Concrete

Vertical Hardie Siding

Wire Mesh Panel

Sheet Metal Reveal

Ptd. Concrete

13' - 2 1/2"

1' - 6" 10' - 0"
Per CPIO Dedication

Stair B

Stair B

Stair B

Stair B

Stair B

Corridor 500

Corridor

400

Corridor

300

Corridor

200

Corridor

Unit A-R 514

Unit A-R

414

Unit A-R 314

Unit A-R

214

T.O. Elevator Roof 1170' - 6"

> T.O. Stair Roof 1164' - 11 1/4"

T.O. Parapet 1159' - 11 3/8"

T.O. Roof 1156' - 5 3/8"

Roof 1155' - 1 1/4"

L04 1136' - 7 5/8"

L03 1126' - 11 3/4"

L02

L01 1107' - 8"

1105' - 3 1/2"

T.O. Slab

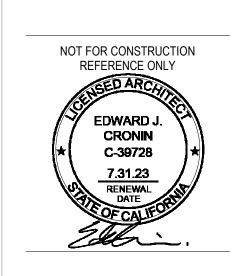
1105' - 0" Elevator Pit 1102' - 8"

Avg Grade Level 1107' - 6 3/8" Lowest Point on Site 20784 Arago Circle Bend, OR 97703 P: (503) 863-1443 W: www.openoffice.design

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verall Building Sections



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1 1/8" = 1'-0" Section E East - West

A4.04

1 3/8" = 1'-0" Long-Term Bike Storage

General Notes

LAMC SEC.12.21.GENERAL PROVISIONS. A. Use. 16. Bicycle Parking and Shower Facilities.

1. **Dwelling Units.** For all residential buildings other than hotels and motels containing more than three dwelling units, longand short-term bicycle parking shall be provided according to the ratios specified for each marginal increment of dwelling units specified in Table 12.21 A.16.(a)(1)(i). A minimum of two short-term bicycle parking spaces shall be provided in all cases. ((a) Land Uses. (1) Residenital. (i) Dwelling Units.)

Table 12.21 A.16.(a)(1)(i)
Required Short-Term and Long-Term Bicycle Parking Spaces by Residential Dwelling Unit

Dwelling Units	Short-Term Spaces	Long-term Spaces	
1 - 25	1 space per 10 units	1 space per unit	
26 - 100	1 space per 15 units	1 space per 1.5 units	
101 - 200	1 space per 20 units	1 space per 2 units	
201 +	1 space per 40 units	1 space per 4 units	

- 2. **Short-Term Bicycle Parking.** Short-term bicycle parking shall consist of bicycle racks that support the bicycle frame at two points. Racks that support only the wheel of the bicycle are not permissible. *((d) Bicycle Parking Facility Requirements. (1) Short-Term Bicycle Parking.)*
- Racks shall allow for the bicycle frame and at least one wheel to be locked to the racks.
- The bicycle rack shall allow for the use of a cable as well as a U-shaped lock.
 If bicycles can be locked to each side of the rack, each side shall be counted toward a required space.
- Racks shall be securely anchored to a permanent surface.
- If more than 20 short-term bicycle parking spaces are provided, at least 50 percent shall be covered by a roof or overhang.
- 3. **Long-Term Bicycle Parking.** Long-term bicycle parking shall be secured from the general public and enclosed on all sides and protect bicycles from inclement weather. *((d) Bicycle Parking Facility Requirements. (2) Long-Term Bicycle Parking.)*
- Acceptable examples of long-term bicycle parking include bicycle lockers, bicycle rooms, bicycle cages, or
- Except in the case of lockers and commercially operated attended bicycle parking, all long-term parking shall provide a
 means of securing the bicycle frame at two points to a securely anchored rack.

4. Dimensions.

- Each bicycle parking space shall be a minimum 6 feet (72 inches) in length. ((e) Design Standards. (1) Dimensions.)
- **Vertical Storage.** Long-term bicycle parking may be mounted so that the bicycle is stored vertically. Such devices that hold the bicycle by the wheel shall be designed to support the bicycle without damaging the wheels.
- Vertically installed bicycle parking shall be a minimum of 4 feet (48 inches) deep and 6 feet (72 inches) in height.
 Stacked Storage. Long-term or short-term bicycle parking may be mounted so that bicycles are stored in a stacked, two-tier layout, provided such parking is primarily an attended bicycle facility where facility staff parks the
- bicycles, or such racks provide mechanical assistance for lifting the bicycle.
 Horizontal Storage. Where bicycles are stored horizontally, devices that hold the bicycle upright by wheel contact shall hold at least 180 degrees of wheel arc.
- Short-term bicycle parking spaces shall be a minimum of 2 feet (24 inches) wide.

commercially operated attended bicycle facilities.

- Individual racks installed beside each other that allow bicycles to be locked to either side of the rack shall be spaced a minimum of 30 inches on center.
- Racks installed parallel to walls shall be a minimum of 30 inches from the wall, except that bicycle parking spaces
 providing a tray or channel for insertion of bicycle wheels may be placed a minimum of 20 inches from the wall, or
 14 inches from the wall if such spaces are on the upper level of a stacked, two tier rack.
- 14 inches from the wall if such spaces are on the upper level of a stacked, two-tier rack.
 Bicycle parking spaces arranged in a vertically staggered layout that permits bicycles to be placed in and removed from each individual space without interference from bicycles in adjoining spaces may be spaced a minimum of 16 inches on center.
- Long-term bicycle parking spaces shall be sized to permit safe, efficient, and convenient access to each individual bicycle parking space without interference from bicycles in adjoining spaces, as described below:
- Individual racks installed beside each other within bicycle rooms or bicycle cages that allow bicycles to be locked to either side of the rack shall be spaced a minimum of 30 inches on center.
- Racks installed parallel to walls shall be a minimum of 30 inches from the wall, with the exception that bicycle
 parking spaces that provide a tray into which the bicycle wheels may be inserted may be placed a minimum of 20
 inches from the wall, or 14 inches from the wall if such spaces are on the upper level of a stacked, two-tier rack.
- Triangular lockers with varying widths may be used so long as the opening is at least 2 feet (24 inches) wide.
 Bicycle parking spaces arranged in a vertically staggered layout that permits bicycles to be placed in and
- removed from each individual space without interference from bicycles in adjoining spaces may be spaced a minimum of 16 inches on center.
- If more than 20 long-term bicycle parking spaces are provided, a workspace of 100 square feet shall be provided adjacent to the long-term bicycle parking to allow bicyclists to maintain their bicycles. However, where long-term bicycle parking is provided in more than one location, a single workspace may be provided adjacent to the location with the greatest number of long-term bicycle parking spaces.
- For single-tiered bicycle parking, minimum headroom of 7 feet (84 inches) shall be provided. For facilities where two tiers of bicycle parking are installed one above another, minimum headroom of 4 feet (48 inches) shall be provided for
- Bicycle parking spaces shall be separated from automobile parking spaces or aisles by a wall, fence, or curb or by at least 5 feet of open space marked to prohibit parking.
- least 5 feet of open space marked to prohibit parking.
 Where bicycle parking is adjacent to accessible automobile parking, aisles or loading areas provided for accessible
- spaces may count towards the open space requirement for bicycle parking so long as they are immediately adjacent to the bicycle parking.



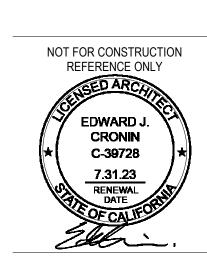
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Enlarged Bike Storage Plans & Details



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